FIRSTNET/AT&T SITE ID: CCL06249

FIRSTNET/AT&T SITE NAME: HILL ROAD AND PARKWAY

INTERSECTION

FA LOCATION CODE: 15532196 **USID:** 319474

PACE ID:

MRSFR077622

PSTC SITE #: SITE ADDRESS: COUNTY:

AT&T

SITE TYPE: **TOWER HEIGHT:** CANC-NLAKE01

3275 HILL RD AND PARKWAY INTERSECTION LAKEPORT, CA 95453

LAKE

MONOPINE

80'-0"

SITE INFORMATION

HILL ROAD AND PARKWAY INTERSECTION PSTC SITE NAME: 3275 HILL RD SITE ADDRESS: LAKEPORT, CA 95453 COUNTY LAKE MAP/PARCEL#: 005-015-410-0000 AREA OF CONSTRUCTION: 13.843 SQ FT LATITUDE: N 39° 04' 40.04" (39.077789°) LONGITUDE W 122° 55' 59.75" (-122.933264°) LAT/LONG TYPE: NAD83 1470.1'± AGRICULTURE

GROUND ELEVATION: CURRENT LAND USE: LAKE COUNTY JURISDICTION: OCCUPANCY CLASSIFICATION: TYPE OF CONSTRUCTION: A D A COMPLIANCE

FACILITY IS LINMANNED AND NOT FOR HUMAN HABITATION

PROPERTY OWNER: CARPENTER JAMES M 200 NORTH MAIN ST #C LAKEPORT, CA 95453

PUBLIC SAFETY TOWERS, LLC 1903 WRIGHT PLACE, SUITE 140 CARLSBAD, CA 92008

CARRIER/APPLICANT

5005 EXECUTIVE PKWY SAN RAMON, CA 94583

ELECTRIC PROVIDER: PG&E TELCO PROVIDER: TBD

TOWER OWNER:

DRAWING INDEX

SHEET #	SHEET DESCRIPTION	REV			
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C-1.1	SITE PLAN	J			
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C-4.1	CONSTRUCTION DETAILS	J			
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E-1	AC PANEL SCHEDULE	J			
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ALL DRAWINGS CONTAINED HEREIN ARE FORMATTED FOR 24x36.					

ALL DRAWINGS CONTAINED HEREIN ARE FORMATTED FOR 24x36.
CONTRACTOR SHALL VERIFY ALL PLANS AND EXISTING DIMENSIONS
AND CONDITIONS ON THE JOB SITE AND SHALL IMMEDIATELY NOTIFY
THE ENGINEER IN WRITING OF ANY DISCREPANCIES BEFORE
PROCEEDING WITH THE WORK OR BE RESPONSIBLE FOR SAME.

LOCATION MAP



AT&T (RF): _ DATE: AT&T OPERATIONS: DATE:

APPROVALS

DIRECTIONS FROM 5005 EXECUTIVE PARKWAY SAN RAMON, CA 95843: GET ON 1-680 N IN DANVILLE FROM CAMINO RAMON (1.9 MI), CONTINUE ON 1-680 N. TAKE CA-29 TO HWY 175 W IN MIDDLETOWN (91.6 MI) TAKE BOTTLE ROCK RD TO CA-29 N/HWY 175 W IN KELSEYVILLE (19 MI) FOLLOW CA-29 N TO PARK WAY IN NORTH LAKEPORT, TAKE EXIT 106 FROM CA-29 N. (12.8 MI) FOLLOW HILL RD E TO YOUR DESTINATION (1.9 MI)

PROJECT TEAM

PUBLIC SAFETY TOWERS, LLC

1903 WRIGHT PLACE, SUITE 140 CARLSBAD CA 92008 STEPHANIE VANDERVEEN S.VANDERVEEN@PSTCTOWERS.COM (619) 417-9925

TEP PROJECT TEAM: TOWER ENGINEERING PROFESSIONALS 4710 E ELWOOD ST. STE 9 PHOENIX, AZ 85040

SITE ACCUINITION CONTACT: CAROL KINCHELOE CKINCHELOE@TEPGROUP.NET (619) 488-0933

CIVIL ENGINEER: ANDREW T. HALDANE, PE AHALADANE@TEPGROUP.NET

(919) 661-6351 ELECTRICAL ENGINEER: MARK QUAKENBUSH, PE

MQUAKENBUSH@TEPGROUP.NET (919) 661-6351

AT&T PROJECT TEAM

RE ENGINEER

EDWIN AVILES EA5477@ATT.COM

PROJECT DESCRIPTION

THE PURPOSE OF THIS PROJECT IS TO ENHANCE BROADBAND CONNECTIVITY AND CAPACITY IN THE AREA FOR EMERGENCY SERVICE AND WIRELESS CUSTOMERS.

TOWER SCOPE OF WORK

• INSTALL 80'-0" MONOPINE TOWER • INSTALL (15) ANTENNAS

INSTALL (15) RADIOS
 INSTALL (3) DC9 SQUIDS

. INSTALL (9) DC POWER TRUNKS

• INSTALL (3) FIBER TRUNKS INSTALL (3) SECTOR MOUNTS
 INSTALL (3) MODIFIED RRH MOUNTS

SPOUND SCOPE OF WORK

ROUND SCOPE OF WORK

INSTALL 33'-0"x33'-0" CHAIN-LINK FENCED COMPOUND

INSTALL (1) 600A GUTTER AND 200A METER ON PROPOSED H-FRAME\
INSTALL 17'-7"x10'-4" CONCRETE PAD

• INSTALL (1) EQUIPMENT PLATFORM

INSTALL (1) WALK-UP-CABINET (WUC)
 INSTALL (1) 30 KW DIESEL GENERATOR

• INSTALL (1) RAYCAP DC50 BOX • INSTALL (1) 30"x30"x12" HOFFMAN BOX WITH CIENA ABOVE • INSTALL ICE BRIDGE

APPLICABLE CODES/REFERENCE DOCUMENTS

ALL WORK SHALL BE PERFORMED AND MATERIALS INSTALLED IN ACCORDANCE WITH THE CURRENT EDITIONS OF THE FOLLOWING CODES AS ADOPTED BY THE LOCAL GOVERNING AUTHORITIES. NOTHING IN THESE PLANS IS TO BE CONSTRUED TO PERMIT WORK NOT CONFORMING TO THESE CODES:

CODE TYPE BUILDING MECHANICAL 2022 CMC (2021 UMC) 2022 CEC (2020 NEC) EIA/TIA-222H ELECTRICAL

REFERENCE DOCUMENTS:

RFDS VERSION: 1.00 UPDATED: 07/07/2023



DATE:

CALL CALIFORNIA ONE CALL (800) 227-2600 **CALL 3 WORKING DAYS** BEFORE YOU DIG!

PUBLICSAFETY TOWERS 1903 WRIGHT PLACE, SUITE 140 CARLSBAD, CA 92008





FIRSTNET/AT&T SITE ID: CCL06249

PSTC #: CANC-NLAKE01 HILL ROAD AND PARKWAY INTERSECTION

3275 HILL RD LAKEPORT, CA 95453 (LAKE COUNTY)

PROPOSED 80'-0" MONOPINE TOWER

	ISSUED FOR:						
REV DATE DRWN DESCRIPTION QA							
F	03-24-23	550	ZONING	HMM			
G	11-16-23	550	ZONING	HMM			
Н	11-21-23	CAM	ZONING	HMM			
_	01-11-24	CAM	ZONING	HMM			
	02-19-24	SIA	ZONING	HMM			



TITLE SHEET

SHEET NUMBER: REVISION:

TEP #:

PROJECT NOTES:

- ALL REFERENCES MADE TO OWNER IN THESE DOCUMENTS SHALL BE CONSIDERED PUBLIC SAFETY TOWERS, LLC OR ITS DESIGNATED REPRESENTATIVE.
- 2. ALL WORK PRESENTED ON THESE DRAWINGS MUST BE COMPLETED BY THE CONTRACTOR UNLESS NOTED OTHERWISE. THE CONTRACTOR MUST HAVE CONSIDERABLE EXPERIENCE IN THE PERFORMANCE OF WORK SIMILAR TO THAT DESCRIBED HEREIN. BY ACCEPTANCE OF THIS ASSIGNMENT, THE CONTRACTOR IS ATTESTING TO HAVE SUFFICIENT EXPERIENCE AND ABILITY, IS KNOWLEDGEABLE OF THE WORK TO BE PERFORMED AND THAT IS PROPERLY LICENSED AND PROPERLY REGISTERED TO DO THIS WORK IN THE STATE THE TOWER IS LOCATED.
- THE STRUCTURE SHALL BE DESIGNED IN ACCORDANCE WITH ANSI/TIA-222-H AND CONFORM TO THE REQUIREMENTS OF THE 2022 CALIFORNIA BUILDING CODE.
- 4. WORK SHALL BE COMPLETED IN ACCORDANCE WITH THE 2022 CALIFORNIA BUILDING CODE.
- 5. UNLESS SHOWN OR NOTED OTHERWISE ON THE CONTRACT DRAWINGS, OR IN THE SPECIFICATIONS, THE FOLLOWING NOTES SHALL APPLY TO THE MATERIALS LISTED HEREIN, AND TO THE PROCEDURES TO BE USED ON THIS PROJECT.
- ALL HARDWARE ASSEMBLY MANUFACTURER'S INSTRUCTION SHALL BE FOLLOWED EXACTLY AND SHALL SUPERSEDE ANY CONFLICTING NOTES ENCLOSED HEREIN.
- 7. IT IS THE CONTRACTOR'S SOLE RESPONSIBILITY TO DETERMINE ERECTION PROCEDURE AND SEQUENCE TO ENSURE THE SAFETY OF THE STRUCTURE AND ITS COMPONENT PARTS DURING ERECTION AND/OR FIELD MODIFICATIONS, THIS INCLUDES, BUT NOT LIMITED TO, THE ADDITION OF TEMPORARY BRACING, GUYS OR TIE DOWNS THAT MAY BE NECESSARY, SUCH MATERIAL SHALL BE REMOVED AND SHALL REMAIN THE PROPERTY OF THE CONTRACTOR AFTER THE COMPLETION OF THE PROJECT.
- 8. ALL DIMENSIONS, ELEVATIONS, AND EXISTING CONDITIONS SHOWN ON THE DRAWINGS SHALL BE FIELD VERIFIED BY THE CONTRACTOR PRIOR TO BEGINNING ANY MATERIALS ORDERING, FABRICATION OF CONSTRUCTION WORK ON THIS PROJECT. CONTRACTOR SHALL NOT SCALE CONTRACT DRAWINGS IN LIEU OF FIELD VERIFICATION. ANY DISCREPANCIES SHALL BE IMMEDIATELY BROUGHT TO THE ATTENTIONS OF THE OWNER AND THE OWNER'S ENGINEER. THE DISCREPANCIES MUST BE RESOLVED BEFORE THE CONTRACTOR STORED PROCECED WITH THE WORK THE CONTRACT DO NOT INDICATE THE METHOD OF CONSTRUCTION THE CONTRACTOR SHALL SUPERVISE AND DIRECT THE WORK AND SHALL BE SOLELY RESPONSIBLE FOR ALL CONSTRUCTION MEANS, METHODS, TECHNIQUES, SEQUENCES, AND PROCEDURES. OBSERVATION VISITS TO THE SITE BY THE OWNER AND/OR THE ENGINEER SHALL NOT INCLUDE INSPECTION OF THE PROTECTIVE MEASURES OR THE PROCEDURES.
- 9. ALL MATERIALS AND EQUIPMENT FURNISHED SHALL BE NEW AND OF GOOD QUALITY, FREE FROM FAULTS AND DEFECTS AND IN CONFORMANCE WITH THE CONTRACT DOCUMENTS. ANY AND ALL SUBSTITUTIONS MUST BE PROPERLY APPROVED AND AUTHORIZED IN WRITING BY THE OWNER AND ENGINEER PRIOR TO INSTALLATION. THE CONTRACTOR SHALL FURNISH SATISFACTORY EVIDENCE AS TO THE KIND AND QUALITY OF THE MATERIALS AND EQUIPMENT BEING SUBSTITUTED.
- 10. THE CONTRACTOR SHALL BE RESPONSIBLE FOR INITIATING, MAINTAINING, AND SUPERVISING ALL SAFETY PRECAUTIONS AND PROGRAMS IN CONNECTION WITH THE WORK. THE CONTRACTOR IS RESPONSIBLE FOR ENSURING THAT THIS PROJECT AND RELATED WORK COMPLIES WITH ALL APPLICABLE LOCAL, STATE, AND FEDERAL SAFETY CODES AND REGULATIONS GOVERNING THIS WORK, RENTAL CHARGES, SAFETY, PROTECTION, AND MAINTENANCE OF RENTED EQUIPMENT SHALL BE THE CONTRACTOR'S RESPONSIBILITY.
- 11. ACCESS TO THE PROPOSED WORK SITE MAY BE RESTRICTED. THE CONTRACTOR SHALL COORDINATE INTENDED CONSTRUCTION ACTIVITY, INCLUDING WORK SCHEDULE AND MATERIALS ACCESS, WITH THE OWNER PROJECT MANAGER. THIS INCLUDES ALL SPECIFIC MILITARY INSTALLATION INSTRUCTIONS INCLUDING STAFF ACCESS AND GATE SPECIFIC INSTRUCTIONS.
- 12. BILL OF MATERIALS AND PART NUMBERS LISTED ON CONSTRUCTION DRAWINGS ARE INTENDED TO AID CONTRACTOR/OWNER.

 CONTRACTOR/OWNER SHALL VERIFY PARTS AND QUANTITIES WITH MANUFACTURER PRIOR TO BIDDING AND/OR ORDERING
 MATERIAL
- 13. ALL PERMITS THAT MUST BE OBTAINED ARE THE RESPONSIBILITY OF THE CONTRACTOR. THE CONTRACTOR WILL BE RESPONSIBLE FOR ABIDING BY ALL CONDITIONS AND REQUIREMENTS OF THE PERMITS.
- 14. 24 HOURS PRIOR TO THE BEGINNING OF ANY CONSTRUCTION, THE CONTRACTOR MUST NOTIFY THE APPLICABLE JURISDICTIONAL (STATE, COUNTY OR CITY) ENGINEER AS WELL AS ANY REQUIRED NOTICES SPECIFIC TO THE MILITARY INSTITUTION.
- 15. THE CONTRACTOR SHALL REWORK (DRY, SCARIFY, ETC.) ALL MATERIAL NOT SUITABLE FOR SUBGRADE IN ITS PRESENT STATE.
 AFTER REWORKING, IF THE MATERIAL REMAINS UNSUITABLE, THE CONTRACTOR SHALL UNDERCUT THIS MATERIAL AND REPLACE WITH
 APPROVED MATERIAL. ALL SUBGRADES SHALL BE PROOFROILED WITH A FULLY LOADED TANDEM AXLE DUMP TRUCK PRIOR TO
 PAVING. ANY SOFT MATERIALS HALL BE REWORKED OR REPLACED.
- 16. THE CONTRACTOR IS REQUIRED TO MAINTAIN ALL PIPES, DITCHES, AND OTHER DRAINAGE STRUCTURES FREE FROM OBSTRUCTION UNTIL WORK IS ACCEPTED BY THE OWNER. THE CONTRACTOR IS RESPONSIBLE FOR ANY DAMAGES CAUSED BY FAILURE TO MAINTAIN DRAINAGE STRUCTURE IN OPERABLE CONDITION.
- 17. THE OWNER OR OWNERS REPRESENTATIVE SHALL HAVE A SET OF APPROVED PLANS AVAILABLE AT THE SITE AT ALL TIMES WHILE WORK IS BEING PERFORMED. A DESIGNATED RESPONSIBLE EMPLOYEE SHALL BE AVAILABLE FOR CONTACT BY GOVERNING AGENCY INSPECTORS.

- 18. ANY BUILDINGS ON THIS SITE ARE INTENDED TO SHELTER EQUIPMENT WHICH WILL ONLY BE PERIODICALLY MAINTAINED AND ARE
- 19. TEMPORARY FACILITIES FOR PROTECTION OF TOOLS AND EQUIPMENT SHALL CONFORM TO LOCAL REGULATIONS AND SHALL BE THE CONTRACTOR'S RESPONSIBILITY
- 20. THE CONTRACTOR AND ITS SUBCONTRACTORS SHALL CARRY LIABILITY INSURANCE IN THE AMOUNTS AND FORM IN ACCORDANCE WITH OWNER SPECIFICATIONS. CERTIFICATES DEMONSTRATING PROOF OF COVERAGE SHALL BE PROVIDED TO OWNER PRIOR TO THE START OF THE WORK ON THE PROJECT.
- 21. THE CONTRACTOR SHALL CONTACT ALL APPLICABLE UTILITY SERVICES TO VERIFY LOCATIONS OF EXISTING UTILITIES AND REQUIREMENTS FOR NEW UTILITY CONNECTIONS PRIOR TO EXCAVATING.
- 22. THE CONTRACTOR SHALL MAINTAIN THE JOB CLEAR OF TRASH AND BEBRIS, ALL WASTE MATERIALS SHALL BE REMOVED FROM THE SITE PRIOR TO THE SUBSTANTIAL COMPLETION AND PRIOR TO FINAL ACCEPTANCE. THE CONTRACTOR SHALL FURNISH ONE 55 GALLON BARREL OR EQUIVALENT, AND TRASH BAGS, AND SHALL REMOVE TRASH, DEBRIS, ETC., ON A DAILY BASIS.
- 23. THE CONTRACTOR SHALL VISIT THE SITE AND BECOME FAMILIAR WITH ALL CONDITIONS PRIOR TO SUBMITTING THE PROPOSAL. CONTRACTOR SHALL VERIFY ALL DIMENSIONS AND CONDITIONS SHOWN ON THESE DRAWINGS WITH THOSE AT THE SITE. ANY VARIATION WHICH REQUIRES PHYSICAL CHANGE SHALL BE BROUGHT TO THE ATTENTION OF THE OWNER PROJECT ENGINEER FOR FACILITIES/CONSTRUCTION
- 24. THE CONTRACTOR SHALL GUARANTEE THE WORK PERFORMED ON THE PROJECT BY THE CONTRACTOR AND ANY OR ALL OF THE SUBCONTRACTORS WHO PERFORMED WORK FOR THE CONTRACTOR ON THIS PROJECT. THE GUARANTEE SHALL BE FOR A FULL YEAR FOLLOWING ISSUANCE OF THE FINAL PAYMENT OF RETAINAGE. ALL MATERIALS AND WORKMANSHIP SHALL BE WARRANTED FOR ONE YEAR FROM ACCEPTANCE DATE.
- 25. THE CONTRACTOR SHALL PROVIDE DAILY UPDATES IN THE FORM OF WRITTEN NOTIFICATION VIA EMAIL OR APP PHOTOS TO THE BOINGO CONSTRUCTION MANAGER.

UTILITY NOTES:

- APPLY FOR THE UTILITY SERVICE (ELECTRIC) NO LATER THAN THE NEXT BUSINESS DAY FOLLOWING AWARD OF CONTRACT.
 COORDINATE WITH THE ELECTRIC UTILITY COMPANY FOR EXACT TRANSFORMER LOCATION, METERING REQUIREMENTS, AND THE
 SERVICE ROUTING. COORDINATE WITH THE TELEPHONE UTILITY COMPANY FOR EXACT TELEPHONE REQUIREMENTS AND ROUTING OF
 SERVICE.
- ALL UTILITY RELATED WORK SHALL BE PERFORMED IN ACCORDANCE WITH APPLICABLE UTILITY REQUIREMENTS. FIELD TO VERIFY
 EXISTING UTILITY LOCATIONS PRIOR TO CONSTRUCTION.
- 3. THE CONTRACTOR SHALL CONTACT UTILITIES AND LOCATOR SERVICE A MINIMUM OF 72 HOURS PRIOR TO THE START OF CONSTRUCTION.
- 4. CONTRACTOR SHALL PROVIDE TRENCHING AND CONDUITS AS SHOWN OR AS REQUIRED BY LOCAL UTILITY.
- 5. NO PENETRATIONS TO THE TOWER FOUNDATION OF ANY KIND.









FIRSTNET/AT&T SITE ID: CCI 06249

PSTC #: CANC-NLAKE01 HILL ROAD AND PARKWAY INTERSECTION

> 3275 HILL RD LAKEPORT, CA 95453 (LAKE COUNTY)

PROPOSED 80'-0"
MONOPINE TOWER

ISSUED FOR:							
REV DATE DRWN DESCRIPTION QA							
F	03-24-23	550	ZONING	HMM			
G	11-16-23	550	ZONING	HMM			
Н	11-21-23	CAM	ZONING	HMM			
1	01-11-24	CAM	ZONING	HMM			
J	02-19-24	SJA	ZONING	HMM			





IT IS A VIOLATION OF LAW FOR ANY PERSON, INLESS THEY ARE ACTING UNDER THE DIRECTION OF A LICENSED PROFESSIONAL ENGINEER,

HEET TITLE:

GENERAL NOTES

GN-1

REVISION:

TEP#: 314197 336



SURVEY DATE 10/04/2022

BASIS OF BEARING
BEARINGS SHOWN HEREON ARE BASED UPON THE CAUFORNIA
ZONE 2 STATE PLANE COORDINATE SYSTEM BASED ON THE
NORTH AMERICAN DATUM OF 1983/2011) (EPOCH 2019.25).
DETERMINED BY CLOBAL POSITIONNIC SYSTEM EQUIPMENT ON
THE SMARTINET REFERENCE NETWORK.

BENCHMARK
PROJECT ELEVATIONS ESTABLISHED FROM GPS DERIVED
ORTHOMETRIC HEIGHTS BY APPLICATION OF NGS GEOID 12B'
MODELED SEPARATIONS TO ELIPSOID HEIGHTS DETERMINED BY
OBSERVATIONS OF THE "SMARTNE" REAL TIME NETWORK, ALL
ELEVATIONS SHOWN HEREON ARE REFERENCED TO NAVOBB.

GRID—TO—GROUND SCALE FACTOR NOTE ALL BEARINGS AND DISTANCES ARE BASED ON THE CALIFORNIA TWO STATE PLANE COORDINATE ZONE GRID. TO DERIVE GROUND DISTANCES DIVIDE BY 0.99984976

UTILITY NOTES SURVEYOR DOES NOT GUARANTEE THAT ALL UTILITIES ARE SHOWN OR THEN LOCATIONS ARE DETINITE. IT IS THE TOTAL THAT ALL UTILITIES ARE SHOWN OF THE TOTAL THAT ALL UTILITIES PROPOR TO CONSTRUCTION. REPOWAL ELECATION AND / OR REPLACEMENT IS THE RESPONSIBILITY OF THE


SURVEYOR'S NOTES
CONTOURS DERIVED FROM DIRECT FIELD OBSERVATIONS AND
FOLLOW THE CURRENT NATIONAL MAP STANDARDS FOR
VERTICAL ACCURACY.

THE BOUNDARY SHOWN HEREON IS PLOTTED FROM RECORD INFORMATION AND DOES NOT CONSTITUTE A BOUNDARY SURVEY OF THE PROPERTY.

ALL DISTANCES SHOWN HEREON ARE GRID DISTANCES.

SURVEYOR HAS NOT PERFORMED A SEARCH OF PUBLIC RECORDS TO DETERMINE ANY DEFECT IN TITLE ISSUED.



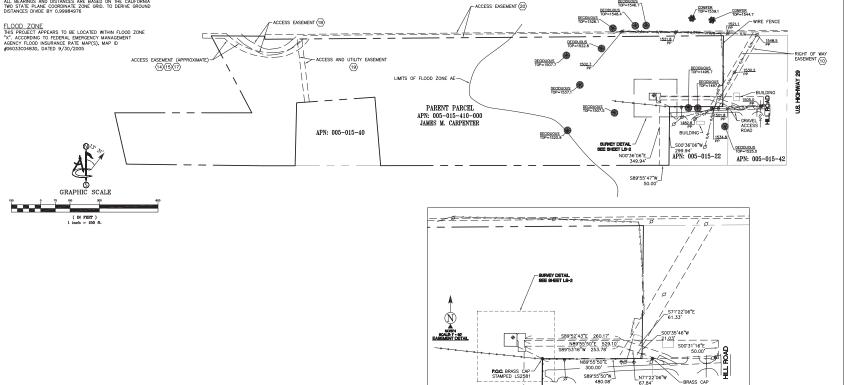



PROJECT INFORMATION:=

CCL06249 HILL ROAD AND PARKWAY INTERSECTION 3275 HILL ROAD LAKEPORT, CA 95453

LAKE COUNTY

ORIGINAL ISSUE DATE:

10/06/2022

REV.:=DATE:===DESCRIPTION:===BY:=						
А	10/06/22	PRELIMINARY	СК			
0	1/05/23	LEGALS (C)	ск			
1	05/15/2023	NEW DESIGN (C)	SB			
2	12/15/2023	NEW DESIGN (C)	PD			

PLANS PREPARED BY:



CONSULTANT:




=CHK.:===APV.:= NS (P) PD



SHEET TITLE:

SITE SURVEY

SHEET NUMBER:=

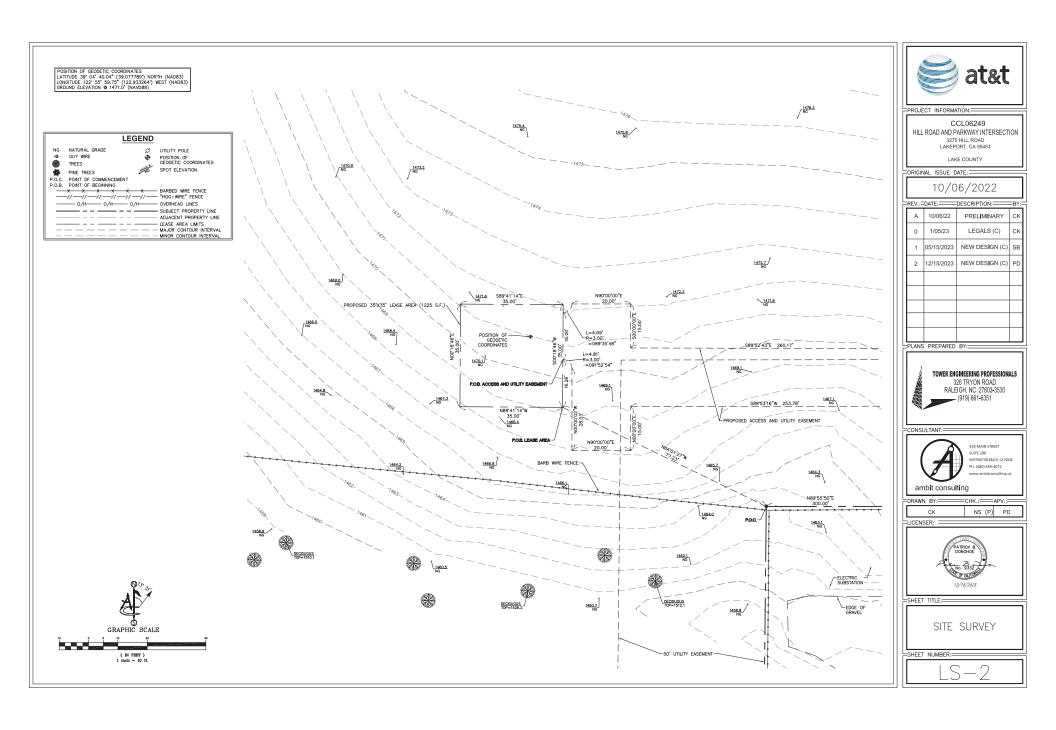

SCHEDULE "B" NOTE REFERENCE IS MADE TO THE TITLE REPORT ORDER #FEP-13845-4, ISSUED BY TOWER TITLE AND CLOSING, DATED AUGUST 5, 2022. ALL EASEMENTS CONTAINED WITHIN SAID TITLE REPORT AFFECTION. "HE, MIMEDIATE AREA SURROUNDING TITLE REPORT AFFECTING ITE INTELLIBERT THE LEASE HAVE BEEN PLOTTED.

ITEMIZED NOTES.

1. DEFECTS, LIEIS, ENCLMBRANCES, ADVERSE CLAMS OR OFFICE MATERIA. PREVAINED IN THE OFFICE MATERIAL PREVAINED IN THE OFFICE MATERIAL PREVAINED AND THE OFFICE MATERIAL PREVAINED AND THE DATE THE PROPOSED INSURED ACQUISES FOR VALUE OF ECONOT THE STATE OR INTEREST OR MORTGAGE THEREON COVERED BY THIS REPORT, INCLUDING.

INCLUDING:
A. TAKES OR ASSESSMENTS THAT ARE NOT SHOWN AS EXISTING LIENS BY THE RECORDS OF ANY TAXING AUTHORITY THAT LEVIES TAXES OR ASSESSMENTS ON REAL PROPERTY OR BY THE PUBLIC RECORDS;
B. PROCEEDINGS BY A PUBLIC AGENCY THAT MAY RESULT IN

B. PROCEEDINGS BY A PUBLIC AGENCY THAT MAY RESULT IN TAXES OR ASSESSMENTS, OR NOTICES OF SUCH PROCEEDINGS, WHETHER OR NOT SHOWN BY THE RECORDS OF SUCH AGENCY OR BY THE PUBLIC RECORDS. (EXCEPTION IS A STANDARD EXCEPTION AND NOT THE TYPE TO BE SHOWN HEREON)

2. THE LIEN OF SUPPLEMENTAL OR ESCAPED ASSESSMENTS OF 2. THE LIEN OF SUPPLEMENTAL OR ESCAPED ASSESSME PROPERTY TAXES, IF ANY. (EXCEPTION IS A STANDARD EXCEPTION AND NOT THE TYPE TO BE SHOWN HEREON)

3. ANY FACTS, RIGHTS, INTERESTS, OR CLAIMS THAT ARE NOT SHOWN BY THE PUBLIC RECORDS BUT THAT COULD BE ASCERTAINED BY AN INSPECTION OF THE LAND OR THAT MAY BE ASSERTED BY PERSONS IN POSSESSION OF THE LAND. (EXCEPTION AND THE TYPE TO

4. EASEMENTS, LIENS OR ENCUMBRANCES, OR CLAIMS THEREOF, NOT SHOWN BY THE PUBLIC RECORDS. (EXCEPTION IS A STANDARD EXCEPTION AND NOT THE TYPE TO BE SHOWN

5. ANY ENCROACHMENT, ENCUMBRANCE, VIOLATION, VARIATION, OR ADVERSE CIRCUMSTANCE AFFECTING THE TITLE THAT WOULD BE DISCLOSED BY AN ACCURATE AND COMPLETE LAND SURVEY OF THE LAND AND NOT SHOWN BY THE PUBLIC RECORDS,

OF HEMOND AND NOT SHOWN BY THE PUBLIC RECORDS,
A. LIMPATENIE MINING CLAMS:
B. RESERVATIONS OR EXCEPTIONS IN PATENTS OR IN ACTS
AUTHORIZON OF ESSUANCE THEREOF WATER,
WHETHER OR NOT THE MATTERS EXCEPTED UNDER (A), (B) OR
(C) ARE SHOWN BY THE PUBLIC RECORDS. (EXCEPTION IS A
STANDARD EXCEPTION AND NOT THE TYPE TO BE SHOWN
HERCOM)

6 ANY LIEN OR RIGHT TO LIEN FOR SERVICES LABOR OR MATERIAL NOT SHOWN BY THE PUBLIC RECORDS. (EXCEPTION IS A STANDARD EXCEPTION AND NOT THE TYPE TO BE SHOWN

7. TAXES FOR THE CURRENT FISCAL YEAR AND SUBSEQUENT YEARS, A LIEN NOT YET DUE AND PAYABLE. (EXCEPTION IS A STANDARD EXCEPTION AND NOT THE TYPE TO BE SHOWN

8. RIGHTS OF FEE SIMPLE OWNERS IN AND TO THE SUBJECT PROPERTY. (EXCEPTION IS A STANDARD EXCEPTION AND NOT THE TYPE TO BE SHOWN HEREON)

9. EASEMENT FOR RIGHT OF WAY BETWEEN JAMES C. BURGER, A SINGLE MAN; AND QUINT C. THOMPSON, DATED NOVEMBER 25, 1916 AND RECORDED NOVEMBER 25, 1916 IN GOOK) 54 (PAGE) 363, IN LAKE COUNTY, CALIFORNIA. (DOES NOT AFFECT PARENT PARELL)

10. RIGHT OF WAY EASEMENT BETWEEN GENE F. BURGER AND LOIS BURGER, HUSBAND AND WIFE; AND PACIFIC GAS AND ELECTRIC COMPANY, A CALIFORNIA CORPORATION, DATED MARCH 19, 1970 AND RECORDED MAY 29, 1970 IN (BOOK) 630 (PACE) 820 (NISTRUMENT) 2414-10-0385, IN LAKE COUNTY, CALIFORNIA. (AS SHOWN ON SURVEY)

11, PACIFIC GAS AND ELECTRIC COMPANY BETWEEN FRED BURGER AND BARBARA BURGER, HUSBAND AND WIFE; AND PACIFIC GAS, AND ELECTRIC COUPANY, A CALIFORNIA CORPORATION, AND FACIFIC BELL, A CALIFORNIA CORPORATION, AND FACIFIC BELL, A CALIFORNIA CORPORATION, PAID AND RECORDED COTOGER 8, 1999 IN (INSTRUMENT) 99-01051, IN LARE COUNTY, CALIFORNIA. (EASEMENT UNDEFINED — NOT FOUTED)

12. ANY AND ALL MATTERS DISCLOSED ON THE MAP ENTITLED RECORD OF SURVEY DATED NOVEMBER 26, 2001 AND RECORDED NOVEMBER 26, 2001 IN (BOOK) 71 (PAGE) 09, IN LAKE COUNTY, CALIFORNIA. (NOTHING TO PLOT)

13. CERTIFICATE OF COMPLIANCE DATED NOVEMBER 30, 2001 AND RECORDED NOVEMBER 30, 2001 IN (INSTRUMENT) 01-024495, IN LAKE COUNTY, CALIFORNIA. (DOES NOT AFFECT PARENT PARCEL)

14, TOGETHER WITH EASEMENTS AND RIGHTS RESERVED IN GRANT DEED TO MICHAEL D. SVEHLA AND NANCY SVEHLA, HUSBAND AND WIFE IN A DEED DATEO COTOBER 24, 2002 RECORDED OCT 30, 2002 AS INSTRUMENT NO. 02-024627 (AS SHOWN ON SURVEY)

SCHEDULE B NOIL

15. ROAD MAINTENANCE ACREEMENT BETWEEN CARPENTER
ORCHARD, INC., A CALIFORNIA CORPORATION AND JAMES M.
CARPENTER, A MARRIED MAN AS HIS SOLE AND SEPARATE
PROPERTY AND MICHAEL AND NANCY SVEHLA, HUSBAND AND
WIFE, DATED GOTOBER 28, 2002 AND RECORDED COTOBER 30, 2002 IN (INSTRUMENT) 02-024628, IN LAKE COUNTY, CALIFORNIA.

2002 M (NESTRUMENT) 02-0024628, IN LAKE COUNTY,
AFFECTED BY A(N) ADDENOUGH #1 TO ROAD MANTENANCE
AGREEMENT BETWEEN JAMES M. CARPENTER, A MARRIED MAN
DEALING WITH IN SEPARATE PROCRETY, AND CARRENTER
DEALING WITH IN SEPARATE PROCRET,
DEALING WITH IN SEPARATE PROCRET,
DEALING WITH IN SEPARATE
OFFICHER BY AND ADDENOUGH AND TO ADD ANAITENANCE
AGREEMENT BETWEEN JAMES M. CARPENTER, A MARRIED MAN
DECHARD, INC., A CAUFORNIA COSPERATION AND SAMUEL
CONNELL, A MARRIED MAN DEALING WITH HIS SEPARATE
PROPERTY, DATED DECCHARER SO, 2005 AND RECORDED
COUNTY, CAUFORNIA (AS SHOWN ON SURVEY). IN LAKE
COUNTY, CAUFORNIA, CAS SHOWN ON SURVEY).

16. LOT LINE ADJUSTMENT DATED DECEMBER 7, 2004 AND RECORDED DECEMBER 7, 2004 IN (INSTRUMENT) 2004033783, IN LAKE COUNTY, CALIFORNIA. (NOTHING TO PLOT)

17. FASEMENTS AS DESCRIBED IN GRANT DEED TO SAMUEL V 17. EASEMENTS AS DESCRIBED IN GRAIN DEED TO SANC CONNELL, A MARRIED MAN DEALING WITH HIS SEPARATE PROPERTY, IN A DEED DATED DECEMBER 20, 2005 AND RECORDED JANUARY 20, 2006 AS INSTRUMENT NO. 2006001602 (AS SHOWN ON SURVEY)

19. EASEMENT GRANT DEED BETWEEN JAMES M. CARPENTER, A MARRIED MAN DEALING WITH HIS SEPARATE PROPERTY, AND CARPENTER ORCHARD, INC., A CALIFORNIA CORPORATION AND SAMUEL V. CONNELL, A MARRIED MAN DEALING WITH HIS SEPARATE P

20. TOGETHER WITH EASEMENTS AND RIGHTS RESERVED IN GRANT DEED TO DAVID RAY COMATSER AND SABRINA LEE CONASTER, HUSBAND AND WIFE, AS JOINT TENANTS, IN A DEED DATED JUNE16, 2007 AND RECORDED JUNE 21, 2017 AS INSTRUMENT NO. 2017-8135 (AS SHOWN ON SURVEY)

LESSOR'S LEGAL DESCRIPTION REAL PROPERTY IN THE UNINCORPORATED AREA OF THE COUNTY OF LAKE, STATE OF CALIFORNIA, DESCRIBED AS

FOLLOWS:
THE SOUTH HALF OF THE SOUTH HALF OF THE MORTHEAST
QUARTER OF SCCTION 11, TOWNSHIP 14 MORTH, RANGE 10
QUARTER OF SCCTION 11, TOWNSHIP 14 MORTH, RANGE 10
EXCEPTING THEREFROM ALL THAT PORTION THEREOF DESCRIBED
AS FOLLOWS:
AS FOLLOWS:
THE NORTHEAST QUARTER OF SECTION 11, TOWNSHIP 14
MORTH, RANGE 10 WEST, MOUTH DIABLE MERDION, WHICH
POINT IS DETERMINED BY RUNNING NORTH ACTION 125TO.
THE NORTHEAST COURTER OF SECTION 11, TOWNSHIP 14
MORTH, RANGE 11 / 14 INCH HERON MOUNDERT MARKON THE
SOUTHEAST CORNER OF SAID SECTION 11 AND RUNNING
HENCE FROM THE 174 INCH HERON MOUNDERT MARKON THE
SOUTHEAST CORNER OF SAID SECTION 11 AND RUNNING
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HENCE THE MORTHEAST QUARTER OF SAID SECTION 11, A
DISTANCE OF SOOLOO FEET, THEREOR MORTHEAST OWN OF THE MORTHEAST COUNTY O SOUTH 8919*40" WEST, ALONG THE SOUTHERLY BOUNDARY LINE OF THE MORTHAST CHARTE OF SAME STOOM 11. THE OF THE MORTHAST CHARTE OF SAME STOOM 11. THE OF THE MORTHAST CHARTEN OF SAME STOOM 11. THE MORTHAST CHARTEN OF THE MORTHAST CHARTEN CHARTEN OF THE MORTHAST CHARTEN OF THE MORTHAST CHARTEN CHARTE

OF SECTION 11, NORTH 0722 41" EAS1, 321.87 FEE1; IHENCE, NORTH 8551'48" EAST, 401.7 FEET, THENCE SOUTH 0448"35" EAST, 351.32 FEET TO THE SAID SOUTH LINE OF THE NORTHEAST OUARTER OF SECTION 11; THENCE SOUTH 89"55'00" WEST ALONG THE SAID SOUTH LINE OF THE NORTHEAST OUARTER, 437.33 FEET TO THE POINT OF BEGINNING.

QUARTER, 437.33 FEET TO THE POINT OF BEDINNING.
PARCEL TWG.
BEONNING AT THE CENTER OF SECTION 11, TOWNSHIP 14
NORTH, RANGE 10 WEST, MOINT DIABLO MERDIAN, AND
RUNNING THENCE MEST, ADONE THE ALM SECTION LINE
SECTION 11, 10, 100 CHAINS TO THE CENTER OF SCOTTS CREEK,
SECTION 11, 10, 100 CHAINS TO THE CENTER OF SCOTTS CREEK,
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THENCE ALONG THE CENTER OF SAID CREEK MORTH 1249
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OF THE SECTION 11,

THENCE SOUTH, 10.46 CHAINS TO THE POINT OF BEGINNING. EXCEPTION THEREFORM THE FOLLOWING DESCRIBED PARKEL OF EXCEPTION THEREFORM THE FOLLOWING DESCRIBED PARKEL OF BECOMING AT THE SOUTHWEST CORNER OF THAT CERTAIN TRACT OF LAND CONVEYED BY JAMES C. BURGER, A SINCE LAND, AND CONVEYED BY JAMES C. BURGER, A SINCE LAND, AND CONVEYED BY JAMES C. BURGER, A SINCE LAND, AND CONTROL TO THE SOUTH LINE OF THE ABOVE REFERRED TO DEED, 60.00 FEET, THENCE LAND, THE ABOVE REFERRED TO DEED, 60.00 FEET, THENCE LAND, THE ABOVE REFERRED TO DEED, 60.00 FEET, THENCE LAND, AND SOUTH LINE OF THE ABOVE REFERRED TO AN EXISTING FENCE, THENCE WESTERLY, JOHNSTREAM, AND CONTROL THE SOUTH LINE OF THE ABOVE REFERRED TO DEED, 50.00 FEET, MORE OF LESS, TO THE CONTROL THE SOUTHWEST SOUTH OF THE SOUTHWEST SOUTHWE

2009 AND RECORDED JANUARY 20, 2006 AS INSTRUMENT NO.
2007 AND RECORDED JANUARY 20, 2006 AS INSTRUMENT NO.
2006 THER WITH EASEMENTS AND RIGHTS RESERVED IN GRANT
DEED TO DAVID RAY CONATSER AND SABRINA LEE CONATSER,
HUSBAND AND WIFE, AS JOINT TENANTS, IN A DEED DATED
JUNE 16, 2007 AND RECORDED JUNE 21, 2017 AS INSTRUMENT
NO. 2017—8135 ECORDED

PARCEL ID: 005-015-410-000

BEING THE SAME PROPERTY CONVEYED TO JAMES M. CAPPENTER, A MARRIED MAN, DEALING WITH HIS SEPARATE CAPPENTER, A MARRIED MAN, DEALING WITH HIS SEPARATE SEPARATE CAPPENTER OF THE C

LEASE AREA LEGAL DESCRIPTION A PORTION OF THAT CERTAIN PARCEL OF LAND AS DESCRIBED IN GRANT DEED RECORDED IN DOCUMENT NO. 200403786. OFFICIAL RECORDS OF LAKE COUNTY, CALIFORNIA, BEING LOCATED IN THE SOUTH HALF OF THE SOUTH HALF OF THE NORTHAND COUNTER OF SECTION 11, TOMNSHET IN A PORTION THAT FOR THE SOUTH HALF OF THE SOUTH HAL

COMMENCING AT A BRASS CAP STAMPED IS 2581 AT THE NORTHWEST CORREP OF 455 CR. 300 AS 9 500M ON RECORD OF 5800 COUNTY, FROM WHIGH A BRASS CAP STAMPED IS 2581 AT THE NORTHEAST CORNER OF 5800 LOT BEARS NORTHEST CORNER OF 5800 LOT BEARS NORTHEST CORNER OF 5800 LOT BEARS NORTHEST STAMPED IS 2581 AT THE NORTHEAST CORNER OF 5800 LOT BEARS NORTHEST STAMPED AND A STAMPED AN

THENCE NORTH 89*41'14" WEST, 35.00 FEFT: THENCE NORTH 0018'46" EAST, 35.00 FEET; THENCE SOUTH 89"41'14" EAST, 35.00 FEET; THENCE SOUTH 00"18'46" WEST, 35.00 FEET TO THE POINT OF BEGINNING.

CONTAINING 1225 SQUARE FEET (0.028 ACRES) OF LAND, MORE OR LESS.

ACCESS AND UTILITY FASEMENT LEGAL DESCRIPTION A PORTION OF THAT CERTAIN PARCEL OF LAND AS DESCRIBED IN GRAIN TEST DESCRIBED IN THE SOUTH HALF OF THE NORTH AS OF THE NORTH AS

COMMENCING AT A BRASS CAP STAMPED LS 2581 AT THE COMMERCIAL A BRASS CAP STAMPED LS 2581 AT THE NORTHWEST CORNER OF 456 OR. 306 AS SHOWN ON RECORD OF SURVEY RECORDED BOOK 17, PAGE 09 OFFICIAL RECORDS OF SAID COUNTY, FROM WHICH A BRASS CAP STAMPED LS 2581 AT THE NORTHEAST CORNER OF SAID LOT BEARS NORTH COMMERCE. 2907 EAST, 300.00 FEET; THENCE FROM SAID POINT OF COMMENCEMENT NORTH 64'01'27" WEST, 77.23 FEET; THENCE NORTH 00'18'46" EAST, 16.26 FEET TO THE POINT OF

BEGNNING,
HENDE CONTINUING NORTH 0018'46" EAST, 16.00 FEET TO
HE BEGNNING OF A NON-TANCENT CURVE, WITH A RADIUS OF
3.00 FEET, CORCAVE NORTHEAST, THE CENTER OF WHICH
BEARS NORTH 0013'20" EAST, THENDE ALONG SAID CURVE,
HROUGH A CENTRAL ANGLE OF 893'544" A DISTANCE OF
4.00.00 FEET, THENDE SOUTH 0000'00" EAST, 15.00 FEET,
HENDE SOUTH 895'24" EAST, 26.017 FEET, THENDE SOUTH
712'206" EAST, 61.33 FEET TO A POINT ON THE EASTERY
BOUNDARY OF SAID PARCEL, THENCE SOUTH 003'546" WEST,
ALONG SAID CHEST WEST, 20.5 FEET, THENCE DEPARTMENT
BY 85'31'16" WEST, 25.37 FEET, THENCE SOUTH 000'00" WEST,
15.00 FEET, THENDE NORTH 900'00" WEST, 20.00 FEET,
15.00 FEET, THENDE SOUTH 000'00" WEST,
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15.00 FEET,
15.00 FEET

50' UTILITY EASEMENT LEGAL DESCRIPTION SU DITLLIT EASEMENT LEGAL DESCRIPTION
A PORTION OF THAT CERTAIN PARCEL OF LAND AS DESCRIBED
IN GRANT DEED RECORDED IN DOCUMENT NO. 2004033786,
OFFICIAL RECORDS OF LAKE COUNTY, CALIFORNIA, BEING
LOCAZED IN THE SOUTH HALF OF THE SOUTH HALF OF THE
NORTHEAST QUARTER OF SECTION 11, TOMNSHIP 14 NORTH,
RANGE 10 WEST, MOINT DIABLO MERDIAN, MORE
PARTICULARLY DESCRIBED AS FOLLOWS:

BEGINNING AT A BRASS CAP STAMPED LS 2581 AT THE NORTHWEST CORNER OF 456 O.R. 306 AS SHOWN ON RECORD OF SURVEY RECORDED BOOK 71, PAGE 03 OFFICIAL RECORDS OF SAID COUNTY, FROW WHICH A BRASS CAP STAMPED LS 2581 AT THE NORTHE og 33 U EASI, 300.00 FEE; HENCE FROM SAID POINT OF BEGINNING SOUTH 0038'06" WEST, 299.94 FEET; THENCE SOUTH 8935'47" WEST, 50.00 FEET; THENCE NORTH 0036'06" EAST, 304.94 FEET; THENCE NORTH 8935'50" EAST, 529.10 FEET; THENCE SOUTH 0031'16" EAST, 50.00 FEET; THENCE SOUTH 8935'50" WEST, 480.06 FEET TO THE POINT OF



PROJECT INFORMATION:=

CCI 06249 HILL ROAD AND PARKWAY INTERSECTION 3275 HILL ROAD

LAKEPORT, CA 95453 LAKE COUNTY

ORIGINAL ISSUE DATE:

10/06/2022

Ļ	REV.:=	DATE:	DESCRIPTION:	BY:
	А	10/06/22	PRELIMINARY	СК
	0	1/05/23	LEGALS (C)	СК
	1	05/15/2023	NEW DESIGN (C)	SB
	2	12/15/2023	NEW DESIGN (C)	PD
	L			
	_			
	_			

PLANS PREPARED BY:



CONSULTANT:



=CHK.:==APV.:= DRAWN BY: NS (P) PD

JCENSER: =



SHEET TITLE:


NOTES

SHEET NUMBER:



- FIBER AND POWER ROUTES SHOWN ARE PRELIMINARY AND TO BE VERIFIED BY COORDINATION WITH THE UTILITY COMPANY PRIOR TO CONSTRUCTION.
- 3. ACCESS WILL BE PROVIDED IN COMPLIANCE WITH PRC 4290.
- A ALCESS MILL BE HEVIVIED IN COMPLIANCE WITH PRC 4290

 4. ADDRESS POSITION FOURIER OF BR DITH CELL LOTIONER LEASE
 SITE AND PRIMARY PROPERTY (RESIDENCE). POSITED BETLECTIVE
 OF REQUIRED SIZE, PERPENDICULAR TO THE ROAD, WISHEL
 FROM BOTH DIRECTIONS AT THE ROADWAY TOR EACH ADDRESS
 ADDRESS SIGN(S) OF CONTRASTING COLORS, RETRO-RETECTIVE
 OF REQUIRED SIZE, PERPENDICULAR TO THE OFFICE THE
 OF REQUIRED SIZE, PERPENDICULAR TO THE OFFICE
 AT EACH ADDRESSED PROPERTY AND/OR STRUCTURE FROM
 THE ORIVENIES.

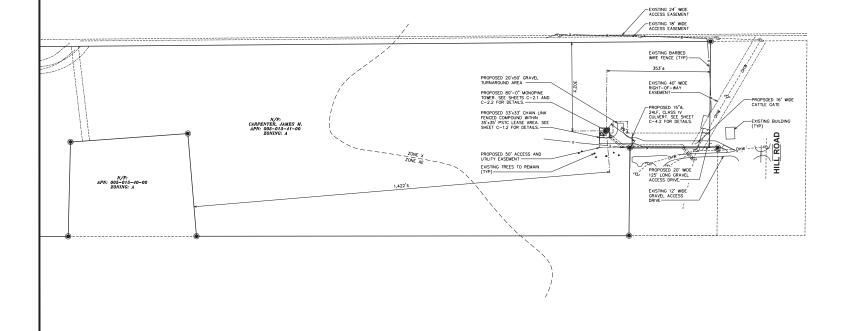



1903 WRIGHT PLACE, SUITE 140 CARLSBAD, CA 92008





FIRSTNET/AT&T SITE ID: CCL06249

PSTC #: CANC-NLAKE01 HILL ROAD AND PARKWAY INTERSECTION

> 3275 HILL RD LAKEPORT, CA 95453 (LAKE COUNTY)

PROPOSED 80'-0" MONOPINE TOWER

ISSUED FOR:							
REV	REV DATE DRWN DESCRIPTION QA						
F	03-24-23	550	ZONING	HMM			
G	11-16-23	550	ZONING	HMM			
Н	11-21-23	CAM	ZONING	HMM			
1	01-11-24	CAM	ZONING	HMM			
J	02-19-24	SJA	ZONING	HMM			





SHEET TITLE:

SITE PLAN

SHEET NUMBER:


REVISION:


TEP#:

EXISTING OVERALL SITE PLAN

SCALE: 1" = 100' (24×36)

SCALE: 1" = 200" (11x17)

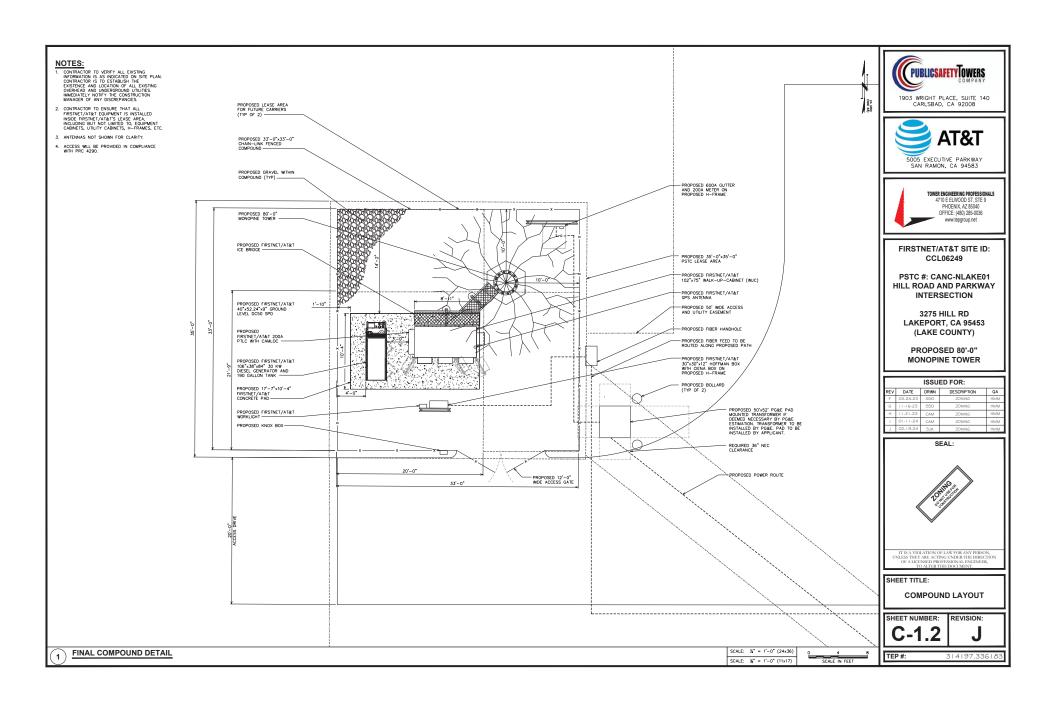

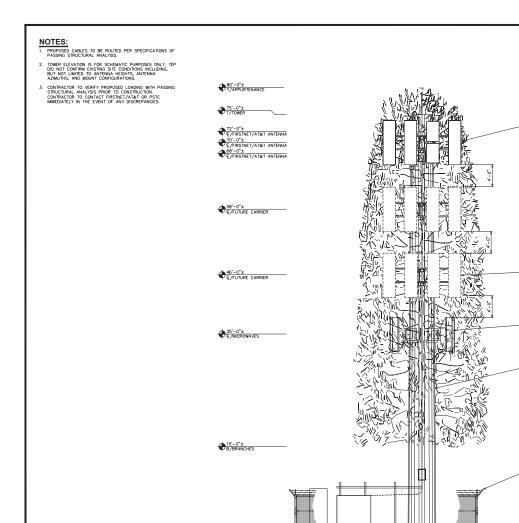

N







FIRSTNET/AT&T SITE ID: CCL06249

PSTC #: CANC-NLAKE01 HILL ROAD AND PARKWAY INTERSECTION

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PROPOSED 80'-0" MONOPINE TOWER

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Н	11-21-23	CAM	ZONING	HMM		
1	01-11-24	CAM	ZONING	HMM		
J	02-19-24	SJA	ZONING	HMM		



FINAL ELEVATION

SHEET NUMBER:

TEP #:


REVISION:



- PROPOSED FIRSTNET/AT&T EQUIPMENT (15) ANTENNAS (15) RADIOS (3) SURGE SUPPRESSORS (3) ANTENNA MOUNTS

FUTURE CARRIER EQUIPMENT (TYP)

-FUTURE MICROWAVE (TYP OF 2)

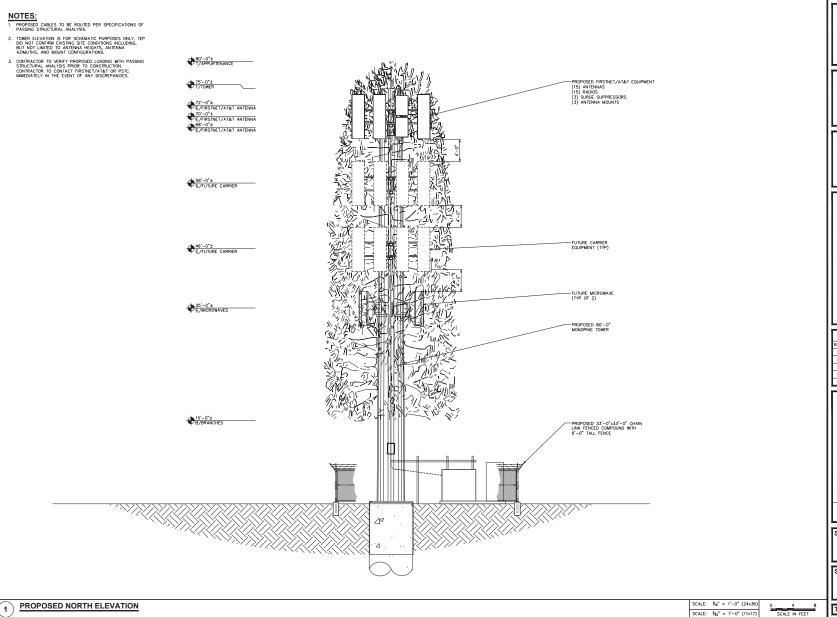



1903 WRIGHT PLACE, SUITE 140 CARLSBAD, CA 92008





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> 3275 HILL RD LAKEPORT, CA 95453 (LAKE COUNTY)

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Н	11-21-23	CAM	ZONING	HMM				
1	01-11-24	CAM	ZONING	HMM				
J	02-19-24	SJA	ZONING	HMM				






FINAL ELEVATION

SHEET NUMBER:

REVISION:

TEP #:

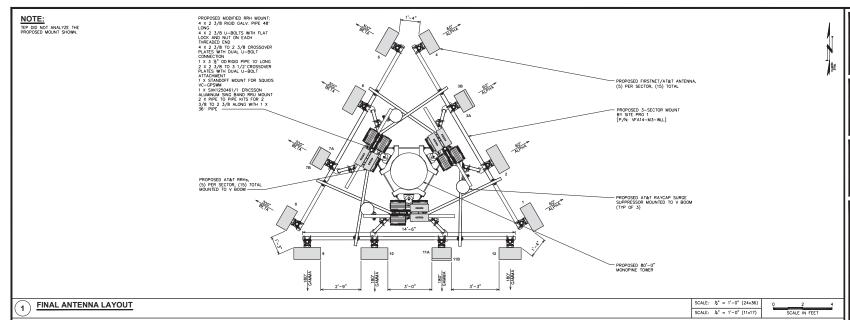

	FINAL ANTENNA/FEEDLINE SCHEDULE								
SECTOR	POS.	MANUFACTURER (MODEL #)	MOUNTING HEIGHT	AZIMUTH (TN)	CABLE SIZE	CABLE LENGTH	OVP/RRH/TMA/DIPLEXER [MODEL #]		
ALPHA	1	QUINTEL (QD868-3D)	€ @ 70°-0°±	60*					
ALPHA	2	QUINTEL (QD868-3D)	€ @ 70°-0°±	60*			(1) RADIO 4478 B12A (1) RADIO 4890 B25/B66		
ALPHA	3A	ERICSSON (AIR6419 B77G)	€ @ 72"-0"±	60*			(1) RADIO 4478 B14 (1) RADIO 2012 B29		
ALPHA	38	ERICSSON (AIR6449 B77M)	€ @ 68'-0*±	60.		(1) RADIO 4415 B30 (1) DC9-48-60-24-8C	(1) RADIO 4415 B30 (1) DC9-48-60-24-8C-EV		
ALPHA	4	QUINTEL (QD868-3D)	€ @ 70°-0*±	60*					
BETA	5	QUINTEL (QD868-3D)	€ @ 70°-0°±	300'					
BETA	6	QUINTEL (QD868-3D)	€ @ 70'-0"±	300'	(9) DC POWER	121'±	(1) RADIO 4478 B12A (1) RADIO 4890 B25/B66		
BETA	7A	ERICSSON (AIR6419 B77G)	€ @ 72°-0°±	300"	TRUNKS (3) FIBER TRUNKS		(1) RADIO 4478 B14 (1) RADIO 2012 B29		
BETA	78	ERICSSON (AIR6449 B77M)	€ @ 68'-0"±	300*			(1) RADIO 4415 B30 (1) DC9-48-60-24-8C-EV		
BETA	8	QUINTEL (QD868-3D)	€ @ 70'-0"±	300*					
GAMMA	9	QUINTEL (QD868-3D)	€ @ 70°-0°±	180*	1				
GAMMA	10	QUINTEL (QD868-3D)	€ @ 70°-0°±	180*			(1) RADIO 4478 B12A (1) RADIO 4890 B25/B66		
GAMMA	11A	ERICSSON (AIR6419 B77G)	€ @ 72°-0°±	180*			(1) RADIO 4478 B14 (1) RADIO 2012 B29		
GAMMA	11B	ERICSSON (AIR6449 B77M)	€ @ 68'-0"±	180*			(1) RADIO 4415 B30 (1) DC9-48-60-24-8C-EV		
GAMMA	12	QUINTEL (QD868-3D)	€ @ 70°-0*±	180*					



1903 WRIGHT PLACE, SUITE 140 CARLSBAD, CA 92008





FIRSTNET/AT&T SITE ID: CCL06249

PSTC #: CANC-NLAKE01 HILL ROAD AND PARKWAY INTERSECTION

> 3275 HILL RD LAKEPORT, CA 95453 (LAKE COUNTY)

PROPOSED 80'-0" MONOPINE TOWER

ISSUED FOR:							
REV	REV DATE DRWN DESCRIPTION QA						
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G	11-16-23	550	ZONING	HMM			
Н	11-21-23	CAM	ZONING	HMM			
1	01-11-24	CAM	ZONING	HMM			
J	02-19-24	SJA	ZONING	HMM			




IT IS A VIOLATION OF LAW FOR ANY PERSON, UNLESS THEY ARE ACTING UNDER THE DIRECTION OF A LICENSED PROFESSIONAL ENGINEER,

ANTENNA LAYOUT &
SCHEDULE

SHEET NUMBER: REVISION:

TEP#: 314197.33618

2 FINAL ANTENNA SCHEDULE SCALE: N.T.S.

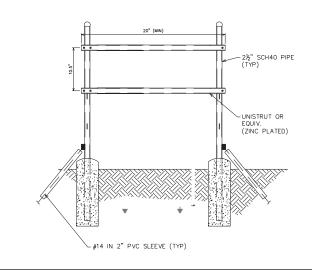







FIRSTNET/AT&T SITE ID: CCL06249

PSTC #: CANC-NLAKE01 HILL ROAD AND PARKWAY INTERSECTION

> 3275 HILL RD LAKEPORT, CA 95453 (LAKE COUNTY)

PROPOSED 80'-0" MONOPINE TOWER

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REV	DATE	DRWN	DESCRIPTION	QA		
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G	11-16-23	550	ZONING	HMM		
Н	11-21-23	CAM	ZONING	HMM		
_	01-11-24	CAM	ZONING	HMM		
	02 19 24	SIA	7ONING	HMM		



CONSTRUCTION DETAILS

SHEET NUMBER:

REVISION:


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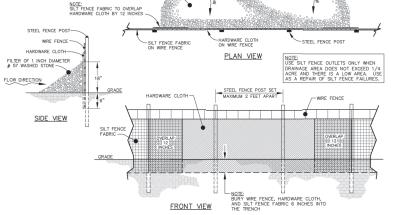
314197 336



NOTES:

- 1. FILTER FABRIC SHALL CONFORM TO THE REQUIREMENTS LISTED IN ASTM D 6461.
- ENDS OF INDIVIDUAL FILTER FABRIC SHALL BE SECURELY FASTENED AT A SUPPORT POST WITH 4 FEET MINIMUM OVERLAP TO THE NEXT POST.
- 3. PLACE 12 INCHES OF FABRIC ALONG THE BOTTOM AND SIDE OF THE TRENCH.
- INSPECT SEDIMENT FENCE(S) AT LEAST ONCE A WEEK AND AFTER EACH RAINFALL.
- REMOVE SEDIMENT DEPOSITS AS NECESSARY TO PROVIDE ADEQUATE STORAGE VOLUME FOR THE NEXT RAIN AND TO REDUCE PRESSURE ON THE FENCE.
- AFTER CONSTRUCTION IS COMPLETE, THE CONTRACTOR SHALL REMOVE ALL FENCING MATERIALS AND UNSTABLE SEDIMENT DEPOSITS, BRING THE AREA TO GRADE AND PROPERLY STABILIZE THE SITE.




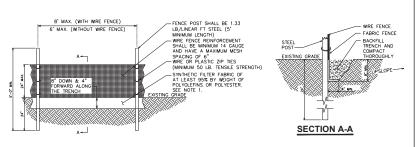


FILTER OF 1 INCH DIAMETER # 57 WASHED STONE


STANDARD SILT FENCE OUTLET DETAIL
SCALE: N.T.S. (4)

SILT FENCE DETAILS (з)

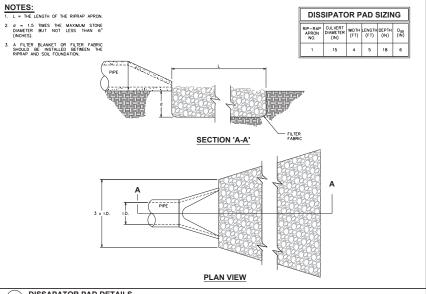

DISSAPATOR PAD DETAILS
SCALE: N.T.S.

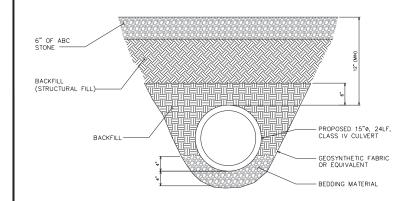

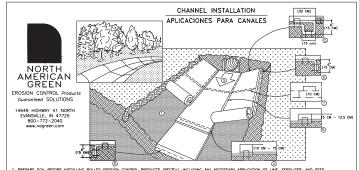

PREPARE SOIL BEFORE INSTALLING ROLLED EROSION CONTROL PRODUCTS (RECP's), INCLUDING ANY NECESSARY APPLICATION OF LIME, FERTILIZER, AND SEED. NOTE: WHEN USING CELL-O-SEED DO NOT SEED PREPARED AREA. CELL-O-SEED MUST BE INSTALLED WITH PAPER SIDE DOWN.

PLACE CONSECUTIVE RECP's END OVER END (SHINGLE STYLE) WITH A 4" - 6" (10 CM -15 CM) OVERLAP. USE A DOUBLE ROW OF STAPLES STAGGERED 4" (10 CM) APART AND 4" (10 CM) ON CENTER TO SECURE RECP's.


AMAIN MOVE - (10 OU) ON CENTEM TO SECURE RECUPS.

FULL LIDENTH, EDGE OF RECUP & IT OFF SIDE SLOWERS MUST BE ANCHORED WITH IA FOW OF STAMPLES/STAKES APPROXIMATELY 12" (30 CM) APART IN A 6" (15 CM)

EAULECT RECUP & (15 CM) WEST REMOCH. BEACHEL AND COMPACT THE TRESCH ATTER STAMPLES AND ATTEMPTS APPROXIMATELY 2" > 5" (5 CM - 12.5 CM) (DEPROMO ON RECUP 1 TYPE) AND STAMPLED.

7. IN HIGH TIGHT CHANNEL BAPPENDERGE, A STURY CHECK SUP IS RECOMMENDED AT 30 TO GO FOOT (9 Mr. - 12 M) INTERNALS. USE A DUBBLE ROW OF STAPLES STAGGERED 4" (10 M) APAIR AND 4" (10 M) APAIR IN A 6" (15 CM) DEEP X 6" (15 CM) ONE TRENCH. BACKFOLL AND COMPANT THE TRENCH ATTER STAFLING.

NOTE:
* IN LOOSE SOIL CONDITIONS, THE USE OF STAPLE OR STAKE LENGTHS GREATER THAN 6" (15 CM) MAY BE NECESSARY TO PROPERLY ANCHOR THE RECP'S.

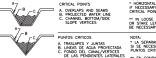

 HORIZONTAL STAPLE SPACING SHOULD BE ALTERED IF NECESSARY TO ALLOW STAPLES TO SECURE THE CRITICAL POINTS ALONG THE CHANNEL SURFACE. ** IN LOOSE SOIL CONDITIONS, THE USE OF STAPLE OR STAKE LENGTHS GREATER THAN 6" (15 cm) MAY BE NECESSARY TO PROPERLY ANCHOR THE RECP'S.

CULOUR CUMPICE-FUNDIENTES RE PATRON DE ENGRAPADO APROPADO.

COLOQUE LAS MANTAS CONSECUTIVAS BORDE SOBRE BORDE (TIPO ESCALONADO) CON UN TRASLAPE DE 4" - 6" (10 CM - 15 CM). USE UNA LINEA DOBLE DE GRAPAS ESCALONADOS, SEPARADAS POR 4" (10 CM) Y CADA 4" (10 CM) Y CADA

ESCLUDIOS, SENSIDIOS POR 4" (TO CH) Y COM 4" (TO CH) SOBRE EL CENTRO PIAN ASSOCIAR LAS MANTES. CON UNIL LIBER, DE COMPAGO DESTACAS, PROPRIMADORISTO CON 17 CON 17 CON UNIL LIBER, DE COMPAGO DESTACAS, PROPRIMADORISTO CON 17 CON UNIL LIBER, DE COMPAGO DESTACAS, PROPRIMADORISTO CON 17 CON UNIL LIBER, DE COMPAGO DESTACAS, PROPRIMADORISTO CON 17 CON UNIL LIBER, DE COMPAGO DESTACAS, DEL CONTROLLER DE COMPAGO DE CONTROLLER DE CONTROLLER DE COMPAGO DE CONTROLLER DE COMPAGO DE CONTROLLER DE CONTROLLER DE CONTROLLER DE COMPAGO DE CONTROLLER DE

7. EN APLICACIONES PARA CANALES DE FLUXO ALTO, SE RECOMIENDA DEJAR UNA RANURA PARA EL CHEQUEO DE LAS GRAPAS A INTERVALOS DE 30 A 40 PIES (9 M - 12 M). USE UNA LINEA DOBLE DE PRAPAS ESCALONADAS, SEPARADAS POR 4° (10 CM) Y CADA 4° (10 CM) SOBRE EL CENTRO A TRAVES DE 1000 EL ANCHO DEL CANAL.

BLOS BORDES FINALES DE LAS MANTAS DEBEN SUJETARSE CON UNA LINEA DE GRAPAS O ESTACAS APROXIMADAMENTE CADA 12° 30 CM) UNA DE LA OTRA EN UNA ZANJA DE 6° (15 CM) DE PROFUNDIDAD POR 6° (15 CM) DE ANCHO, RELIENE Y COMPACTE DESPUES DEL ENGRAPADO.

NOTA:
• EN CONDICIONES DE SUELTO, PUEDE QUE SE NECESITEN GRAPAS O ESTACAS DE MAS DE 6° (15 CM) DE LARGO PARA ASEGURAR LAS MANTAS CORRECTAMENTE.

REV. 01.105

REV. 01.105



1903 WRIGHT PLACE, SUITE 140 CARLSBAD, CA 92008





FIRSTNET/AT&T SITE ID: CCL06249

PSTC #: CANC-NLAKE01 HILL ROAD AND PARKWAY INTERSECTION

> 3275 HILL RD LAKEPORT, CA 95453 (LAKE COUNTY)

PROPOSED 80'-0" MONOPINE TOWER

ISSUED FOR:							
REV	DATE	DRWN	DESCRIPTION	QA			
F	03-24-23	550	ZONING	HMM			
G	11-16-23	550	ZONING	HMM			
Н	11-21-23	CAM	ZONING	HMM			
1	01-11-24	CAM	ZONING	HMM			





CONSTRUCTION DETAILS

SHEET NUMBER:

REVISION

TEP #: 314197 336

EROSION CONTROL MATTING DETAIL (з)

CULVERT DETAIL
SCALE: N.T.S. (2)


SCALE: N.T.S.

A DELTA

A DELTA

▲ NELTA

System Configuration

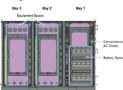

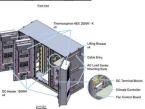



Figure 2-2 Multi-Bay Cabinet (Front View)

Cabinet Specifications

The cabinet is arranged for installation of a Delta or third-perty AC Load Center and front access DC Power System. Table 2-1 below contains the input power specifications.

Item	Specification/Function					
AC Input Range						
AC Input Voltage	1W+N+FG 100~120V _{AC}					
AC Input Current (maximum)	12A (Max.)					
AC Input Frequency	50/60Hz					
DC Input Range						
DC Input Voltage	40 - 60Vpc (54V typical)					
DC Input Current Rating	224A (max)					
Battery Section						
Battery Trays	(3) Trays arranged for -48V battery strings, designer for: GNB Marathon M12V180FT Enersys SBS190F Enersys SBS170F					
Climate Control						
Control & Supervisor Unit	Delta controller					
Cooling	(3) 200W/*K Thermosiphon HEX Cooling Capacity 9.1kW Maintains equipment inlet <65°C with exterior ambient <46°C					
Heating	(4) 1500W DC Heaters					
Environmental						
Operating Temperature	-40°C to +46°C (-40°F to +115°F)					
Storage Temperature	-40°C to +75°C (-40°F to +167°F)					
Relative Humidity	0~95% Relative Humidity, Non-Condensing					
Altitude	-100 feet to +10,000 feet					
Acoustic noise	≤ 65dBA @ +40°C equipment inlef					
Protection Class	IP55 (EN 60529) NEBS III (GR-487)					

Dimensions and Weight

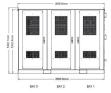



Fgure 2-3 Cabinet Dimensions

Item	Specification/Function					
Dimensions	2600.8W x 1932.4H x 1266.1D mm (102"W x 72"H x 49.5"D + 4" plinth)					
Weight	2270* lbs. (* Batteries, Power System and Load Equipment excluded)					

▲ BELTA

ADELTA

FIRSTNET/AT&T SITE ID:

PSTC #: CANC-NLAKE01 HILL ROAD AND PARKWAY INTERSECTION

CCL06249

PUBLICSAFETYTOWERS

1903 WRIGHT PLACE, SUITE 140 CARLSBAD, CA 92008

5005 EXECUTIVE PARKWAY SAN RAMON, CA 94583

AT&T

TOWER ENGINEERING PROFESSIONALS 4710 E ELWOOD ST, STE 9 PHOENIX, AZ 85040 OFFICE: (480) 285-0036

3275 HILL RD LAKEPORT, CA 95453 (LAKE COUNTY)

PROPOSED 80'-0" MONOPINE TOWER

ISSUED FOR: REV DATE DRWN DESCRIPTION QA

SEAL:



WALK-UP-CABINET DETAILS

SHEET NUMBER: **C-5**

TEP #:

314197.33618

REVISION:

▲ belta

3.6 Cabinet Installation

Use the following steps to install the cabinet.

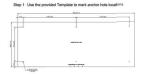


Figure 3-11 Mounting Template

Step 2 Drill anchor holes per specifications from the anchor manufacturer Step 3 Install anchors per instructions from the anchor manufacturer.



Step 6 Close and secure hinged anchor access covers.

3.8 AC Load Center Installation

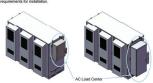


Figure 3-16 Cabinet with AC Load Center





Figure 3-18 AC Load Center - ATS

Note! The cabinet provides mounting rails and AC cable entry ports arranged for mounting of intersect PTLC-4XTS-12200-CL; or equivalent AC Load Center. An AC Load Center and railsed fillings are not provided with the val

Step 1 Provide suitable sealed fittings from the AC Load Cetter for entry into the Cabinet. Install on the Load Center before installing he Load Center onto the Cabinet. Delta recommends using Size 2" x 4" long outdoor rated pipe nipples and sealing conduit nuts (not provided)

Step 2 Provide Intersect PTLC-MTS-12200-CL or equivalent AC Load Center. Secure the Load Center to mounting rails per Load Center vendor

Step 3 Secure and seal fittings from the AC Load Center irto entry ports on the

Step 4 Confirm the Site Utility and Load Center Main AC input breakers are in the

Step 5 Connect Ste Utility 2W+N+G to the Load Center per Load Center vendor instructions, NEC, and local codes.

Note! Detailed AC Load Center position planning should include future equipment additions and changes

3-BAY WALK-UP-CABINET (WUC) DETAIL SCALE: N.T.S. **1**)



NOTES:

1. DETAILS SHOWN WERE PROVIDED BY OTHERS AND ARE NOT CARRIED UNDER SIGNATURE AND SEAL OF TOWER ENGINEERING PROFESSIONALS ENGINEERING SERVICES ANDOR ITS ENGINEERS

- INSTALL EXHAUST VENT EXTENSION ASREQUIRED TO PROVIDE 12' CLEARANCE FROM GROUND LEVEL IN ACCORDANCE WITH CALIFORNIA STATE CODE.

SD030 | 2.2L | 30 kW INDUSTRIAL DIESEL GENERATOR SET





GENERAC INDUSTRIAL

N W

Codes and Standards Not all codes and standards apply to all configurations. Contact factory for détails.















ANSI C62.41

Powering Ahead

Generac searched globally to ensure the most reliable engines power

SD030 | 2.2L | 30 kW INDUSTRIAL DIESEL GENERATOR SET

STANDARD FEATURES

FUEL SYSTEM

Fuel Lockoff Solenoid
 Primary Fuel Filter

COOLING SYSTEM

ELECTRICAL SYSTEM

CONTROL SYSTEM

- ENGINE SYSTEM
 - - GENERATOR SET

ALTERNATOR SYSTEM

Alarms and Warnings

Full System Status Display

SD030 | 2.2L | 30 kW INDUSTRIAL DIESEL GENERATOR SET

CONFIGURABLE OPTIONS

GENERAC INDUSTRIAL

ENCLOSURE (If Selected)

FUEL TANKS (If Selected)

GENERAC INDUSTRIAL

ENGINE SYSTEM

FUEL SYSTEM O NPT Flexible but Line

ELECTRICAL SYSTEM 10A UL Listel Battery Charg
 Buttery Warmir ALTERNATOR SYSTEM

Alternator Up:iring Anti-Condensation Heater Trapical Coating Permanent Magnet Excitation

GENERATOR SET

Extended Forcey Tests 8 Position Loyd Center Pad Vibration Societies

ENGINE SYSTEM Coolant Heafer Isolation Ball Valv
 Fluid Containment Pan

CONTROL SYSTEM

Spare Inputs (x4) / Outputs (x4)
 Battery Discouncet Switch

CONTROL SYSTEM

CONTROL SYSTEM
MFM 110 Complained 21-Light Remote Annuclator
Remote Replay Secretity (B or 15)
Remote Replay Secretity (B or 15)
Old Temperater Motional and Alarm
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1207 OF Remote Complexioner. Modern

FUEL TANKS (Size On Last Page)

GENERAC INDUSTRIAL

WARRANTY (Standby Gensets Only

ENGINEERED OPTIONS

SD030 | 2.2L | 30 kW

DIMENSIONS AND WEIGHTS

INDUSTRIAL DIESEL GENERATOR SET

PROPOSED 30 KW GENERATOR WITH 190 GALLON TANK AND LEVEL 2 ACOUSTIC ENCLOSURE -

Generac Power Systems, Inc. | P.O. Box 8 | Waukesha, WI S3189 P. (262) 544-411 0/2020 Generac Power Systems, Inc. All rights reserved. All specifications are subject to change without notice.

ALTERNATOR SYSTEM

CIRCUIT BREAKER OPTIONS

GENERATOR SET

FUEL TANKS Ut.2085 Tank Stainless Steel Yanks Special Fuel Tanks Vent Extensions

GENERAC INDUSTRIAL

L x W x H - in (mm)

LxWxH-in (mm)

LEVEL 2 SOUND ATTENUATED ENCLOSURE Ly Wy H - in (mee) Steel Aluminum

Part No. 10000024842 Rev. C 10/19/2020

Run Time Usable Capacity - Gal (L)

OFFICE: (480) 285-0036

FIRSTNET/AT&T SITE ID: CCL06249

PUBLICSAFETY TOWERS

1903 WRIGHT PLACE, SUITE 140 CARLSBAD, CA 92008

5005 EXECUTIVE PARKWAY

AT&T

TOWER ENGINEERING PROFESSIONALS

4710 F FLWOOD ST STE 9

PHOENIX, AZ 85040

PSTC #: CANC-NLAKE01 HILL ROAD AND PARKWAY INTERSECTION

> 3275 HILL RD LAKEPORT, CA 95453 (LAKE COUNTY)

PROPOSED 80'-0" MONOPINE TOWER

ISSUED FOR: REV DATE DRWN DESCRIPTION QA



IT IS A VIOLATION OF LAW FOR ANY PERSON, UNLESS THEY ARE ACTING UNDER THE DIRECTI OF A LICENSED PROFESSIONAL ENGINEER,

GENERATOR DETAILS

SHEET NUMBER: **C-6**

REVISION:

TEP #: 314197 3361

SD030 | 2.2L | 30 kW INDUSTRIAL DIESEL GENERATOR SET

APPLICATION AND ENGINEERING DATA

Fuel System

Governor Electroni
Programs y Proprintion (Steady State) ±0.5% Lubrication System

ALTERNATOR SPECIFICATIONS

(es		4	Rearings	Single Staled
std Type		Revolving	Coupling	Direct via Flexible Disc
sulation Class	Rotor	Н	Load Capacity - Standby	100%
sulation Class	Stator	Н	Prototype Short Circuit Test	Yes
tal Harmonic D	istorion	<5% (3-Phase Only)	Voltage Regulator Type	Digital
	rence Factor (TIF)	< 50	Number of Sensed Phases	All

For over 69 years, Conerso has provided innovative design and superior manufacturing.

Generac ensures superior quality by designing and manufactu most of its generator components, including alternators, enclose and base tanks, control systems and communications software.

Generac geneets utilize a wide variety of options, configurations and arrangements, allowing us to meet the standby power needs of practically every application.

our generators. We choose only engines that have already been proven in heavy-duty industrial applications under adverse conditions.

Generac is committed to ensuring our customers' service support continues after their generator purchase.

GENERAC INDUSTRIAL

SD030 | 2.2L | 30 kW INDUSTRIAL DIESEL GENERATOR SET

OPERATING DATE

Total Fuel Pump Flow (Combustion + Return) - gph (Lph)

PROPOSED GENERATOR DETAILS **1** SCALE: N.T.S.

connect@alpinepowersystems.com £ 877-993-8855



Click to view product web page Construction

NEBS™ Certified

SBS Front Terminal

- Robust positive plates are designed to prolong service
- . Separators are low resistance microporous (AGM). The
- Terminals are stainless steel front access with top access copper alloy insert. Top and front access

Installation and Operation

 Space efficient footprint VRLA design, reduces maintenance requirements

cycling capability

- · Lifting handles for easy handling Greater than 10 year life expectancy in float service at 77°F (25°C)
- · Increased active material surface area vields great
- Operating temperature: -40°F (-40°C) to 122°F (50°C)
 Recommended temperature: 68°F (20°C) to 86°F (30°C)

Standards

- . Meets criteria for "non-spillable" batteries Complies with Telcordia® SR-4228, Network Equipment Building System (NEBS™) Criteria Levels
- The management systems governing the manufacture of this product are ISO 9001:2008 and ISO 14001:2004







FIRSTNET/AT&T SITE ID: CCL06249

PSTC #: CANC-NLAKE01 HILL ROAD AND PARKWAY INTERSECTION

> 3275 HILL RD LAKEPORT, CA 95453 (LAKE COUNTY)

PROPOSED 80'-0" MONOPINE TOWER

Г		ISSU	ED FOR:	
REV	DATE	DRWN	DESCRIPTION	QA
F	03-24-23	550	ZONING	HMM
G	11-16-23	550	ZONING	HMM
Н	11-21-23	CAM	ZONING	HMM
1	01-11-24	CAM	ZONING	HMM
	00.10.04	0.11	7011110	

SEAL:



BATTERY DETAILS

SHEET NUMBER: REVISION:

C-7

TEP #:

- life and enhance corrosion resistance
- electrolyte is absorbed within the AGM, preventing acid spills in case of accidental damage
- Container and cover in flame retardant UL94-V0 material, highly resistant to shock and vibration
- terminations provide maximum conductivity
- · Self-regulating one way pressure relief valves prevents

General Specifications

	Nominal Ca	pacity (Ah)		Nominal Dimensions							
Cell Type	10 hr rate to 1.80Vpc @20°C	8 hr rate to 1.75Vpc @77°F	Le in	ength mm	in W	idth mm	He in	eight mm	Unpa Ibs	cked kg	
SBS B8F	31	31	11.9	303	3.8	97	6.3	159	22.7	10.3	
SBS B10F	38	38	11.9	303	3.8	97	7.2	184	28.2	12.8	
SBS B14F	62	62	11.9	303	3.8	97	10.4	264	42.0	19.	
SBS C11F	92	91	16.4	417	4.1	105	10.1	256	61.6	28.	
SBS 100F	100	100	15.6	395	4.3	108	11.3	287	71.9	32.	
SBS 112F	112	112	22.1	561	4.9	125	9.0	228	90.4	41.	
SBS 145F	145	145	17.9	455	6.8	173	9.4	238	105.0	47.7	
SBS 165F	165	165	17.9	455	6.8	173	10.8	273	117.4	53.	
SBS 170F	170	170	22.1	561	4.9	125	11.1	283	115.7	52.	
SBS 190F	190	190	22.1	561	4.9	125	12.4	316	132.3	60.0	











SBS 1	00F-112F

SBS 145F - 190F





- Capacity range 31-190Ah
- 12V monobloc configurations
- Multiple string configurations available

PowerSafe SBS Front Terminal batteries.

PowerSafe[®]

Battery Range Summary

The PowerSafe® SBS® Front Terminal battery further extends the

do PowerSafe SBS Front Terminal monoblocs retain the benefits

typically associated with Thin Plate Pure Lead (TPPL) Technology such as long life, high energy density, superior shelf life, etc., they

also deliver exceptional cyclic performance in both float and fast

Where conventional Valve Regulated Lead Acid (VRLA)/Absorbed

Glass Mat (AGM) batteries struggle to cope with harsh conditions and frequent power outages, cutting edge (TPPL) technology makes PowerSafe 12V batteries the perfect solution for the challenging

operating conditions of today's telecommunication networks. PowerSafe SBS batteries are designed to high quality standards and a unique manufacturing methods means superior energy and power, high performance and proven reliability, there is no substitute to

charge applications, even in the hottest and harshest operating

technical leadership of PowerSafe SBS battery product line: not only

Telecommunications

environments.


- . Two year shelf life
- SR4228 compliant
- Proven long service life
- · High energy density and cycling capability

	ALPINE POWER SYSTEMS
	POWERSAFE SBS 190F
BATTERY QTY.:	8 UNITS
TOTAL BATTERY KWH:	18.24
TOTAL BATTERY WEIGHT (KG/LBS):	480 / 1058.4
TOTAL ELECTROLYTE VOLUME (GAL):	18.72
TOTAL ELECTROLYTE WEIGHT (KG/LBS):	129.5 / 285.4

Publication No: US-SBSF-RS-004 - January 2014



PROPOSED BATTERY DETAILS
SCALE: N.T.S.

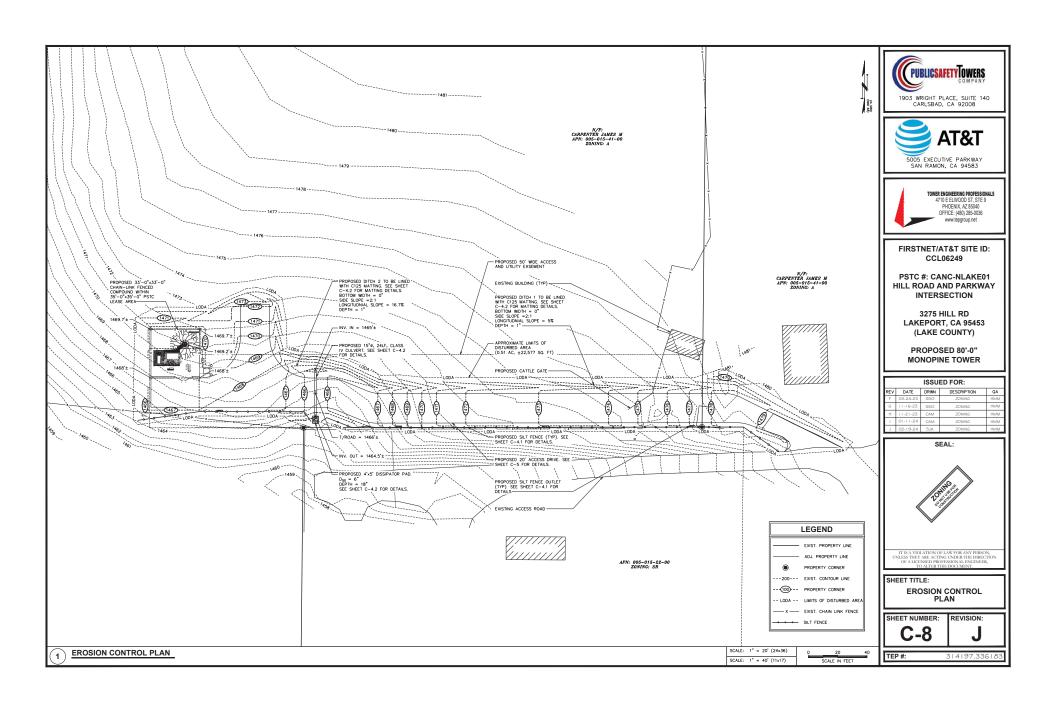

				AC POV	VER PANE	L A (PRO	POSED)				
120/240 VOLTS, 1-PHASE, 3-WIRE, 200A											
MAIN BREAKER RATING (A) :						200		SYSTEM VOLTAGE (V):			240
DESCRIPTION	VA	c/nc	BKR	POSN	L1	L2	POSN	BKR	c/nc	VA	DESCRIPTION
RECTIFIERS #1 & 2	1410	С	30/2	1	2820		2	30/2	С	1410	RECTIFIERS #3 & 4
RECTIFIERS #1 & Z	1410	С	3012	3		2820	4	3012	С	1410	RECTIFIERS #3 & 4
RECTIFIERS #5 & 6	1410	С	30/2	5	2820		6	30/2	С	1410	RECTIFIERS #7 & 8
RECTIFIERS #3 & 0	1410	С	3012	7		2820	8	JUIZ	С	1410	RECTIFIERS #1 & 0
RECTIFIERS #9 & 10	1410	С	30/2	9	2820		10	30/2	С	1410	RECTIFIERS #11 & 12
RECTIFIERS #5 & 10	1410	С	3012	11		2820	12	JUIZ	С	1410	RECTIFIERS #11 & 12
SPARE / OFF	0	nc	30/2	13	0		14	30/2	nc	0	SPARE / OFF
SPARE / OFF	0	nc	3012	15		0	16	30/2 n	nc	0	SPARE / OFF
SPARE / OFF	0	nc	nc 30/2 17 0		18	30/2	nc	0	SPARE / OFF		
SPARE / OFF	0	nc	JUIZ	19		0	20	JUIZ	nc	0	SPARL / OFF
SPARE / OFF	0	nc	30/2	21	0		22	30/2	nc	0	SPARE / OFF
SPARE / OFF	0	nc	JUIZ	23		0	24	JUIZ	nc	0	SPARL / OFF
BLANK				25	1000		26	20/1	nc	1000	*GEN BLOCK HEATER
BLANK				27		650	28	20/1	nc	650	*GEN BATT CHARGER
PTLC RECEPTACLES	720	nc	20/1	29	900		30	20/1	nc	180	WUC GFCI
	F	PHAS	E TOTAL	S (VA):	10360	9110					
	PHASE TOTALS (A):			LS (A):	86	76					
CURRENT PER PHAS	CURRENT PER PHASE W/ 125% Continuous Loads(A):			104	94	Amperes	/phase ca	annot	exceed m	ain breaker rating	
	PANEL TOTAL (VA):			194	19470 Legend: c = continuous, nc = non-continuous				s, nc = non-continuous		
PANEL TOTAL \	N/ 125% C	ontinu	ious Load	ls (VA):	237	23700					
TOTA	L LOAD FO	OR GE	EN OPER	RATION:	178	320	*Generat	or loads a	are no	t in operat	tion while generator is running

PROPOSED LOADING = 23.7 KVA







FIRSTNET/AT&T SITE ID: CCL06249

PSTC #: CANC-NLAKE01 HILL ROAD AND PARKWAY INTERSECTION

> 3275 HILL RD LAKEPORT, CA 95453 (LAKE COUNTY)

PROPOSED 80'-0"
MONOPINE TOWER

ISSUED FOR:									
REV	DATE	DRWN	DESCRIPTION	QA					
F	03-24-23	550	ZONING	HMM					
G	11-16-23	990	ZONING	HMM					
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1	01-11-24	CAM	ZONING	HMM					
J	02-19-24	SJA	ZONING	HMM					



IT IS A VIOLATION OF LAW FOR ANY PERSON, UNLESS THEY ARE ACTING UNDER THE DIRECTION COLUMED WITH DESCRIPTION OF THE COLUMN

SHEET TITLE:

AC PANEL
SCHEDULE

SHEET NUMBER: REVISION:

TEP#: 314197.33618

1 AC PANEL SCHEDULE
SCALE: N.T.S.

