


SITE PLAN

SCALE: 1" = 20'-0"

2 DAYS BEFORE YOU DIG CALL USA TOLL FREE 1-800-227-2600

SITE PLAN

CROSS DEVELOPMENT, LLC 17430 CAMPBELL ROAD, SUITE 225, DALLAS, TEXAS 73252

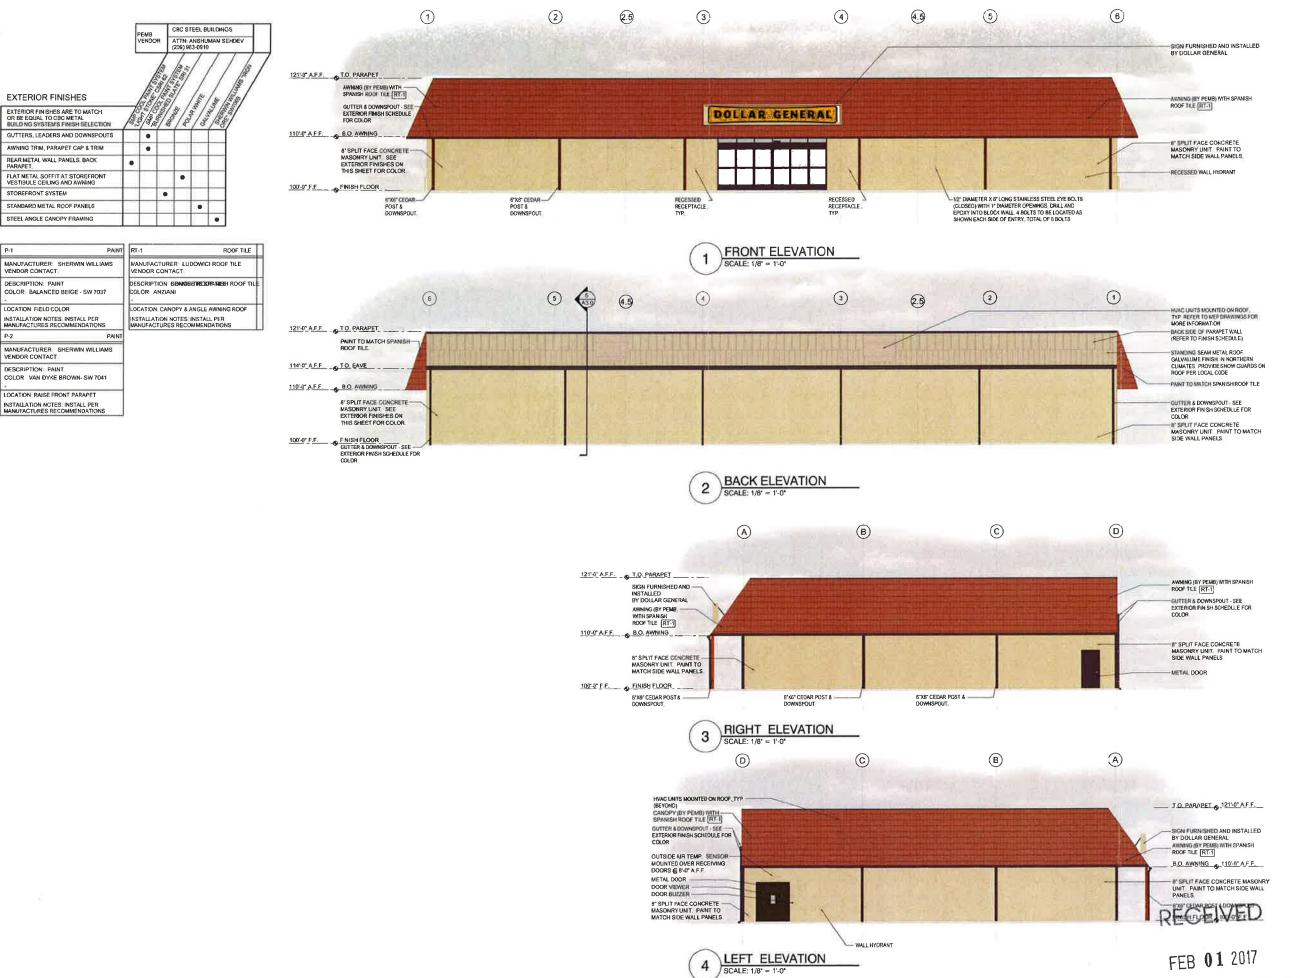

ARCHITECT:
BRIAN RUMSEY
1255 W. 15TH. ST.
SUITE 125
PLANO, TEXAS 75075
PH: 972.398.6644
FAX: 972.312.8666

DOLLAR GENERAL KELSEYVILLE, CA


PROJECT:
DOLLAR GENERAL
9781 POINT LAKEVIEW RD.
KELSEYVILLE, CA
LAKE COUNTY

REVISIONS
NO DATE

DRAWINGS ISSUED FOR:
20JAN15\_80% DESIGN SET

DATE:
02/01/2017
PROJ. NO:
13082
SHEET NUMBER
A2.0
EXTERIOR
ELEVATIONS
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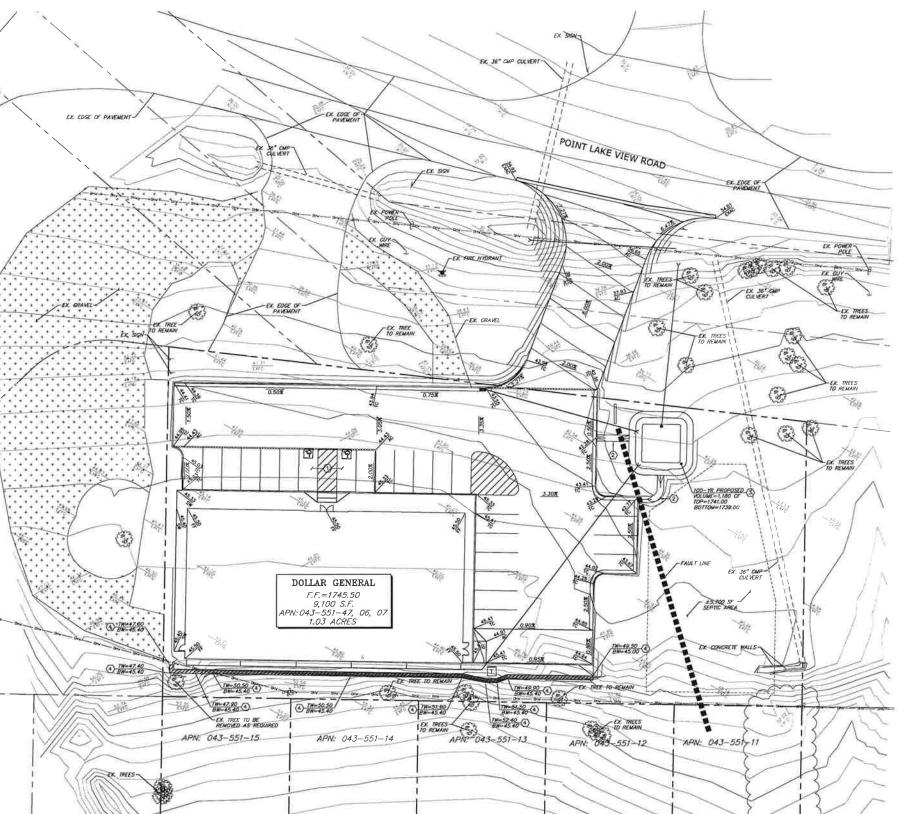
LAKE COUNTY COMMUNITY
DEVELOPMENT DEPT.

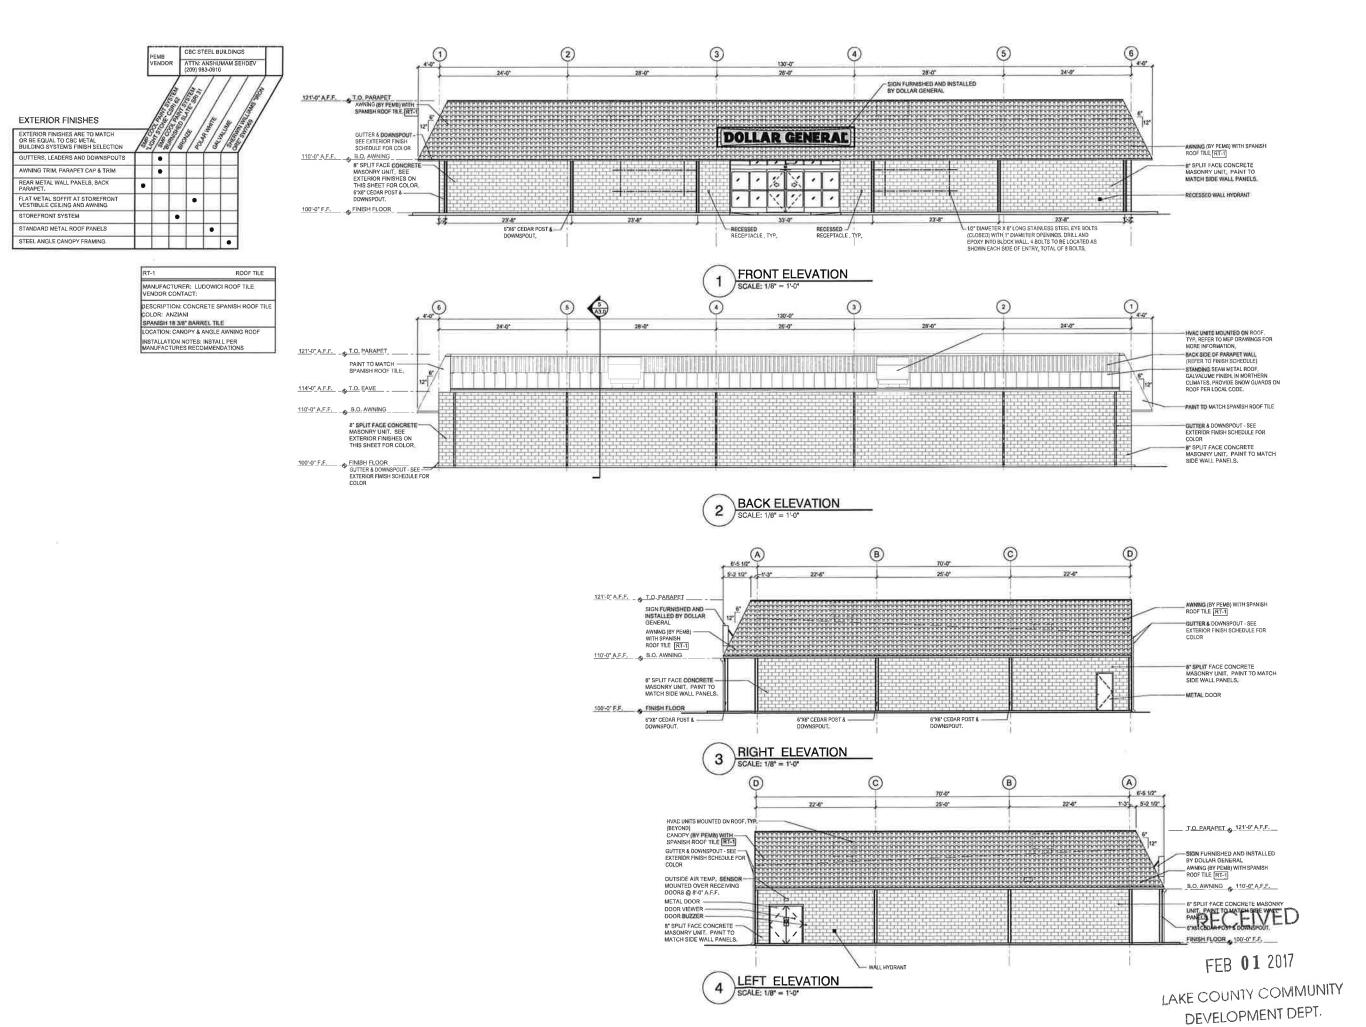

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# DOLLAR GENERAL KELSEYVILLE, CA

9781 KELS	ECT: AR GENERAL POINT LAKEVIEW RD. EYVILLE, CA COUNTY
ı	REVISIONS
NO	DATE
-	
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DRAW	INGS ISSUED FOR:
ZDJAN	15_80% DESIGN SET
DAT	E: 02/01/2017
PRO	13082
	SHEET NUMBER
	42.0
	EXTERIOR
F	LEVATIONS
_	Copyright @ 2014



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DESIGNED: CHECKED/STAMPED:

**PRELIMINARY** DESIGN

TECTONICS DESIGN GROUP

1 ADD 1,700 TO ALL FINISHED GRADE OR INVERT ELEVATIONS

ACCESSIBLE PARKING AND UNLOADING SPACES SHALL HAVE A MAXIMUM 2% SLOPE/CROSS SLOPE AS PER 2010 CBC1129N.3.4

PROPOSED RETAINING WALL TO BE PROVIDED AS A DESIGN BUILD BY THE CONTRACTOR.

CONSTRUCTION NOTES:

2. INSTALL GROUTED RIFRAP LINED SWALE 3. CONSTRUCT LANDSCAPE DETENTION BASIN

Dollar General
Kelseyville, CA
CROSS DEVELOPMENT, LLC
17430 CAMPBELL ROAD, SUITE 225, DALLAS, TEXAS 75252

SUBMITTAL

12/03/15


GRADING PLAN

C3.1

GRADING PLAN

SCALE: 1" = 20'-0"

2 DAYS BEFORE YOU DIG CALL USA TOLL FREE 1-800-227-2600

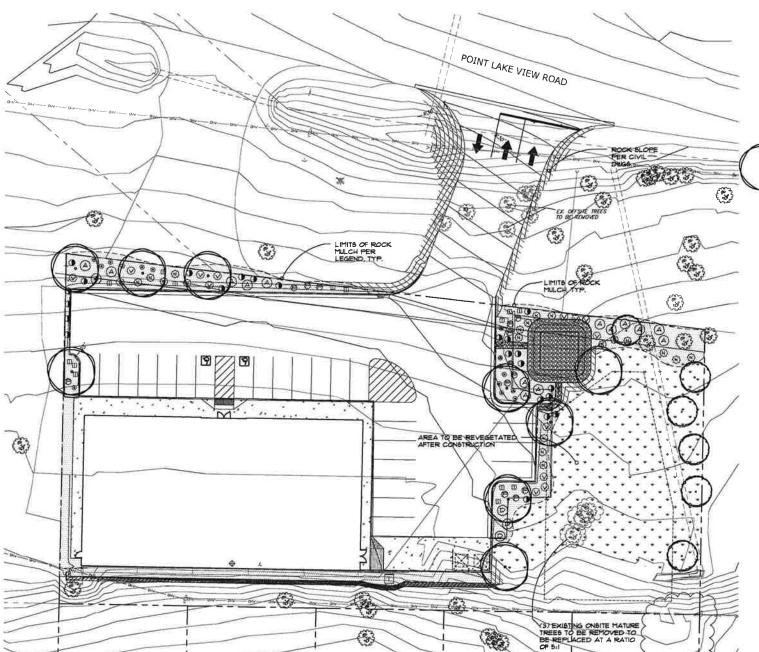

# PLANT LIST: WATER REGIME LISTED IS PER WUCOLS REGION 2

SIZE WATER REGIME MATURE HABIT 6YM, NO. BOTANICAL NAME COMMON NAME EXISTING TREE TO REMAIN EXISTING TREE TO BE REMOVED TO BE REPLACED AT A RATIO OF 5:1 (9 TREES REQUIRED) IS NEW SITE TREES PROPOSED PER PLAN. TREES S GAL. 6' MIN HT. 40 × 40 PINUS ELDARICA PINE 15 GAL. 125' CAL. L 22 × 12 QUERCUS DOUGLASII BLUE OAK BROOMS RUSSIAN SAGE G Ø GENISTA E GOLD ELASHI 5 GAL 1 × 2 5 GAL 3 × 3 PEROVSKIA A "BLUE SPIRE" CISTUS X 'PURPUREA' ARCTOSTAPHYLOS U. 'GREEN SUPREME' ROCK ROSE MANZANITA 5 GAL 4 X 4 1 X 5 PHORMIUM T. 'DUET' NEW ZEALAND FLAX P DODONAFA PURPURFA HOPSEED PERENNIALS

CATMINT

MAIDEN GRASS

BLUE OAT GRASS

# LANDSCAPE LEGEND

HELICTOTRICHON SEMPERVIRENS

NEPETA WALKERS LOW

OENOTHERA SPECIOSA

23 MISCANTHUS 6. 'ADIAGO'

GRASSES

ROCK RIP RAP PER CIVIL DWGS

ROCK MULCH - 3" MIN DEPTH OF I 1/2" ROCK GRAY
ALL PLANTER AREAS AS SHOWN, ROCK AVAILABLE FROM LOCAL SOURCE
PLACE OVER DEMIT PRO 5 OR EGUAL MEED BARRIER FABRIC
PLACE 3" DEPTH OF SHREDDED CEDAR OR PIRE MULCH IN PLANT BASINS
INSTALL WEED BARRIER FABRIC PER MFS. DIRECTION REVEGETED AREA: SEED WITH CALIFORNIA NATIVE GRASS MIX AVAILABLE FROM PACIFIC COAST SEED, LIVERMORE, CA

1 GAL.

I GAL

 $1 \times 2$ 

NOT

BARK MULCH-3' MIN. DEPTH OF SHREDDED BARK MULCH ALL PLANT BASINS ONLY. REFER PLANTING DETAILS SHEET L-3.1.

SUBMIT SAMPLE OF FABRIC AND MULCH FOR APPROVAL, ALL ROCK SHALL BE SCREENED FOR DIRT AND DEBRIS PRIOR TO DELIVERY TO THE SITE,

ALL PLANT MATERIAL IS ZONED BY WATER REQUIREMENTS. PLANTS ARE SPECIFIED WITH LOW WATER REQUIREMENTS FOR WATER CONSERVATION. PLANTS ARE PLACED TO ALLOW FOR GROWTH TO THEIR NATURAL SHAPE TO MINIMIZE MAINTENANCE.

## LANDSCAPE REQUIREMENTS

PARKING AREA LANDSCAPE REQUIRED: TIO 5.F. (5%) PARKING AREA LANDSCAPE PROVIDED: 1650 S.F (11%) MINIMUM PRONTAGE LANDSCAPE REQUIRED 10' (248 L.F.): 2,480 S.F.

TOTAL PARKING AREA: 15,401 S.F.

MINIMUM FINITAGE LANDSCAPE PROVIDED: 2,961 S.F.
TOTAL LANDSCAPE REQUIRED: 3,750 S.F.
TOTAL LANDSCAPE PROVIDED: 4,017 S.F.

# GreenDesign Landscape Architects, Inc. Berbera M. Hatch ASLA

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LANDSCAPE PLAN

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**PRELIMINARY** 

DESIGN

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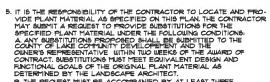
DEVELOPMENT, ROAD, SUTTE 225, DALLAS, TEX

CROSS 17430 CAMPBELL

1/28/16 PREL SUBMITTAL

General

ollar



B. THE REQUEST MUST BE ACCOMPANIED BY AT LEAST THREE NOTICES FROM PLANT SUPPLIERS THAT THE PLANT MATERIAL SPECIFIED IS NOT AVAILABLE PRIOR TO THE CONSTRUCTION

6- ALL PLANTS NOT MEETING OR EXCEEDING REGUIREMENTS AND RECOMMENDATIONS OF ANSI 250.0.1 "AMERICAN STANDARD FOR NURSERY STOCK" AND THE STATE OF CALIFORNIA GRADING CODE FOR PLANT STOCK SHALL BE REJECTED. THE CONTRACTOR SHALL RECEIVE ON-SITE APPROVAL OF PLANT MATERIAL BY THE CUNER'S REPRESENTATIVE PRIOR TO PLANTING, PAILLIRE TO RECEIVE APPROVAL PRIOR TO PLANTING MATA RESULT IN REJECTION AND THE CONTRACTOR SHALL REPLACE ALL REJECTED PLANT MATERIAL AT HIS EXPENSE. THE CUNER RESERVES THE RIGHT TO INSPECT AND EVALUATE PLANT MATERIAL THROUGHOUT THE CONSTRUCTION AND MAINTENANCE PERIOD.

THE CONTRACTOR IS RESPONSIBLE FOR NOTIFYING THE OWNER A MIN. OF 46 HOURS IN ADVANCE FOR THE FOLLOWING SITE OBSERVATIONS AND/OR MEETINGS.

A PRECONSTRUCTION MEETING WITH ALL PARTIES.

B. PLANT MATERIAL ON SITE, PRIOR TO INSTALLATION. C. PLANT LOCATIONS STAKED, PRIOR TO PLANTING. D. FINAL PROJECT WALK-THROUGH



LANDSCAPE NOTES:

THE CONTRACTOR SHALL COORDINATE ALL WORK WITH OTHER TRADES (IE:PAVING, PLUMBING, ELECTRICAL, ETC.)

COMPLETE PRIOR TO PLANTING.

3, SOIL IN THE PLANTER AREAS SHALL BE AMENDED PER
A SOIL ANALYSIS REPORT AND RECOMMENDATIONS PREPARED
BY AN AGRICULTURAL BUILTABILITY SOIL TESTING SERVICE.
ALL SOIL ANALYSIS AND REPORTS SHALL SATISFY THE REQUIREMENTS OF
4925 IN THE CALIFORNIA WATER EFFICIENT LANDSCAPE ORDINANCE FOR A
SOIL MANAGEMENT REPORT TO THE RESPOSIBILITY OF PREPARATION THIS
REPORT SHALL SUSMIT THE REPORT TO THE SENERAL CONTRACTOR FOR
SUSMITTAL TO THE CITY, SHRUB PLANTERS, COLLECT A MINIMUM OF 6 SOIL
SAMPLES FROM ONSITE PLANTER AREAS AFTER PLANTERS HAVE BEEN
BROUSHT TO GRADE FER CIVIL DRAMINISK, THOROUGHLY MIX THE COLLECTED
SAMPLES AND SUBMIT ONE MIXED SAMPLE FOR ANALYSIS WITH
RECOMMENDATIONS FOR CREAKING SOIL AMENDMENT, PLANTER AREA SOILS

SAMPLES AND SUBMIT ONE MIXED SAMPLE FOR ANALYSIS WITH RECOMMENDATIONS FOR ORGANIC SOIL ANEXDMENT, PLANTER AREA SOILS SHALL BE AMENDED PER THE SOIL ANALYSIS I RECOMMENDATIONS PRIOR TO PLANTING, LOOSEN SOIL TO A DEPTH OF 12' PRIOR TO AMENDED RESONATIONS, SPREAD AMENDED RESONATIONS, ANALYSIS RECOMMENDATIONS, RAKE OUT ALL ROCK AND DEBRIS GREATER THAN I 1/2' DIA. RAKE TO ANEVEN GRADE, SOIL REPORT SHALL INCLUDE SOIL INFLITATION RATE FOR IRRIGATION SCHEDULING, ALL PLANTS SHALL BE SPRAYED WITH VERMA-PLEX OR EGUAL ORGANIC POLIAR FERTILIZER AFTER INSTALLATION, SOIL SHALL NOT BE TILLED OR AMENDED WITHIN THE DRIP LINE OF EXISTING TREES, A COPY OF THE SOIL ANALYSIS BHALL BE GUBRITTED.

THE QUINER AND THE CITY ENGINEER.

4. THE CONTRACTOR IS RESPONSIBLE FOR PROVIDING PLANT MATERAIL PER SYMBOLS AND SPACING INDICATED ON THE PLAN. SYMBOLS PREVAIL OVER QUANTITIES LISTED IN THE PLANT LEGEND.

ALL GRADES SHALL BE APROVED BY THE OWNER'S REPRE-

BENTATIVE AFTER IIRRIGATION MAINS AND FINAL GRADING IS COMPLETE PRIOR TO PLANTING.

1. ALL PLANT SUBSTITUTIONS SHALL BE REVIEWED AND ACTION TAKEN BY THE LANDSCAPE ARCHITECT. ALL PLANT MATERIAL SHALL BE APPROVED BY THE LANDSCAPE ARCHITECT AND THE CITY PRIOR TO PLANTING. THE CONTRACTOR SHALL NOTIFY THE OWNER FOR PLANT REVIEW AND APPROVAL 48 HRS. PRIOR TO DELIVERY. ANY MATERIAL NOT ACCEPTABLE SHALL BE REMOVED IMMEDIATELY FROM THE SITE, THE OWNERS REPRESENTATIVE MAY AT ANYTIME WITH FINAL ACCEPTABLE MATERIAL WITHOUT COST TO THE COUNER.

8. THE CONTRACTOR CHALL GUARANTEE ALL PLANT MATERIALS FOR ONE FULL YEAR UPON FINAL ACCEPTANCE OF THE PROJECT. THE CONTRACTOR SHALL MAINTAIN THE SITE INCLIDING WATER SCHEDULING FOR THE ONE YEAR GUARANTEE PERIOD. ANY PLANTS REPLACED UNDER THIS GUARANTEE SHALL BE GUARANTEED FOR ONE FULL YEAR FROM THE DATE OF REPLACEMENT.

9. REMOVE ALL WEEDS AND DEBRIS IN AND AROUND NEWLY INSTALLED PLANT MATERIAL AND EXISTING PLANT MATERIAL.

10 THE LANDSCAPE CONTRACTOR SHALL INSURE POSITIVE DRAINAGE IN ALL PLANTER AREAS PER CIVIL ENGINEERS GRADING PLAN AFTER LANDSCAPE IMPROVEMENTS ARE COMPLETE.

11. MULCH ALL PLANTING SAUCERS WITH THREE INCHES (3) MINIMUM DEPTH OF CHIPPED OR SHREDDED MULCH. REFER TO LEGEND THIS SHEET.

12. ALL SHRUBS WILL BE ON A TIMER CONTROLLED DRIP IRRIGATION SYSTEM PER THE IRRIG. PLAN. ALL PLANT MATERIAL IS SPECIFIED FOR LOW WATER USE AND DROUGHT TOLERANCE.

13. ROOT BARRIERS SHALL BE INSTALLED ADJACENT TO ALL TREES WITHIN S' OF PAVING S' FROM OF THE CENTER OF THE TREE PER DETAIL SHEET LS.I.